MARIN UTILITY UNDERGROUNDING, RECYCLED WATER PIPELINE,


AND THE BUCHANAN MARIN BIKEWAY PHASE III PROJECT

SAN PABLO AVENUE TO MASONIC AVENUE

ALAMEDA COUNTY, CALIFORNIA

CONTRACT NO. C17-1

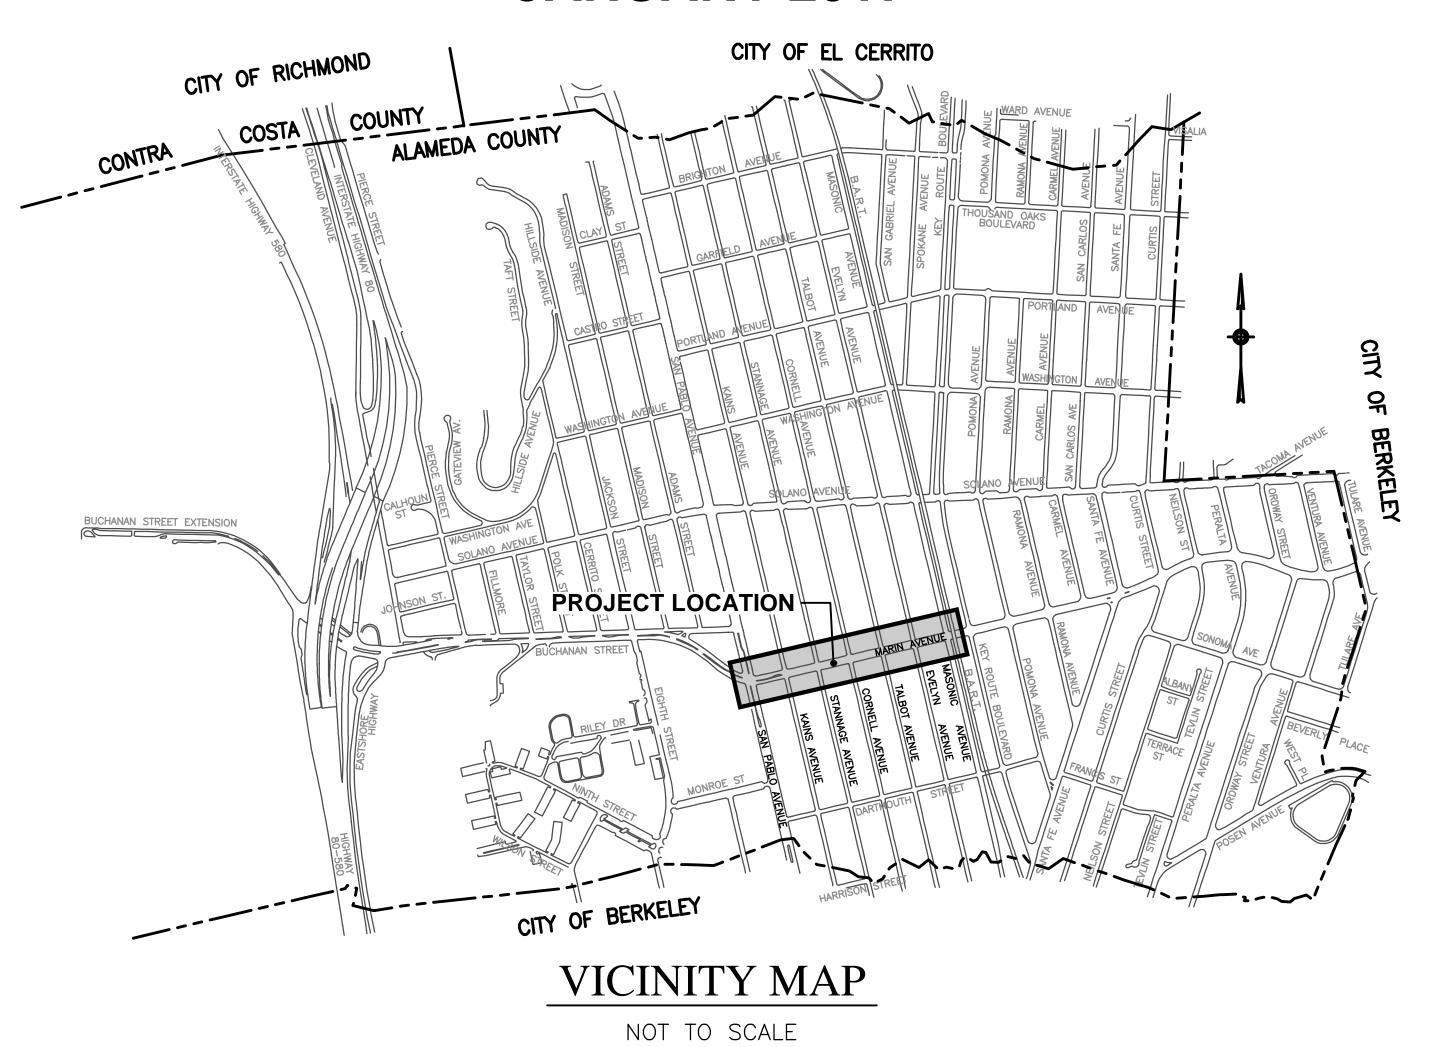JANUARY 2017




CITY COUNCIL

Peggy McQuaid, Mayor Nick Pilch, Vice Mayor Michael Barnes, Councilmember Rochelle Nason, Councilmember Peter Maass, Councilmember

Penelope Leach, City Manager Jeff Bond, Community Developement Director Mark Hurley, Public Works Director/City Engineer (01/20/2017)

CONSTRUCTION

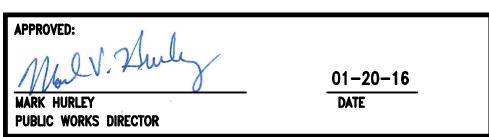22



CAUTION:
HIGH PRESSURE GAS LINES WITH IN PROJECT LIMITS (HPF) EXISTING 8" HPF PARALLEL WITH MARIN AVENUE ALONG NORTH SIDE EXISTING 12" HPF ALONG CENTER LINE OF KAINS AVENUE EXISTING 20" HPF ALONG EAST SIDE OF CORNELL AVENUE CONTRACTOR TO LOCATE LINE PRIOR TO CONSTRUCTION AND NOTIFY ENGINEER OF ANY

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54X22	17		CONFLICTS.	EXERCISE EXTREME <u>CAUTION</u> WHEN WORKING IN VICINITY OF GAS
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DESIGNED BY: J. YOUNG DRAWN BY: J. YOUNG

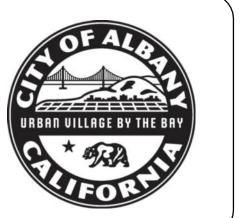
CHECKED BY: REVIEWED BY: R. STEVENS

JANUARY 20, 2017



322 HARBOUR WAY, STE 23 RICHMOND, CA 94801 PH: (510) 529-0336 FAX: (510) 529-0336

MARK HURLEY, CITY OF ALBANY ENGINEER HAS REVIEWED AND APPROVED THE PLANS FOR GENERAL CONFORMANCE WITH THE CITY OF ALBANY STANDARD SPECIFICATIONS AND ORDINANCES



City of Albany

MARIN UTILITY UNDERGROUNDING, RECYCLED WATER PIPELINE, AND THE BUCHANAN MARIN BIKEWAY PHASE III PROJECT

TITLE SHEET

DWG No. (CIVIL SHEETS ONLY) C - 1.0OF

SHEET INDEX		

SHT. REF	DESCRIPTION
C-1.0	TITLE SHEET AND SHEET INDEX
C-2.0	SHEET INDEX
C-2.1	POLLUTION PREVENTION
C-2.2	GENERAL NOTES, ABBREVIATIONS AND LEGEND
C-2.3	HORIZONTAL CONTROL AND TYPICAL SECTIONS
C-3.0	DEMOLITION PLAN - STA 0+00.00 TO STA 5+14.86
C-3.1	DEMOLITION PLAN - STA 5+14.86 TO 11+27.32
C-4.0	HORIZONTAL LAYOUT - STA 0+00.00 TO STA 5+14.86
C-4.1	HORIZONTAL LAYOUT - STA 5+14.86 TO 11+27.32
C-4.2	SURFACE RESTORATION PLAN
C-5.0	GRADING PLAN - STA 0+00.00 TO STA 5+14.86
C-5.1	GRADING PLAN - STA 5+14.86 TO 11+27.32
C-6.0	CURB RETURN PROFILES - MARIN AVENUE AT KAINS AVENUE
C-6.1	CURB RETURN PROFILES - MARIN AVENUE AT STANNAGE AVENUE
C-6.2	CURB RETURN PROFILES - MARIN AVENUE AT CORNELL AVENUE
C-7.0	UTILITY PLAN - STA 0+00.00 TO STA 5+14.86
C-7.1	UTILITY PLAN - STA 5+14.86 TO 11+27.32
C-8.0	SIGNAGE AND STRIPING PLAN - STA 0+00.00 TO STA 5+14.86
C-8.1	SIGNAGE AND STRIPING PLAN - STA 5+14.86 TO 11+27.32
C-9.0	CONSTRUCTION DETAILS
C-9.1	CONSTRUCTION DETAILS - CITY STANDARD PLANS
C-10.0	CONSTRUCTION AREA SIGN LAYOUT
JT-1	JOINT TRENCH TITLE SHEET
JT-2	PHASE 1 - JOINT TRENCH COMPOSITE
JT-3	PHASE 1 - JOINT TRENCH COMPOSITE
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SL-1	ELECTROLIER TITLE SHEET
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SL-5	ELECTROLIER PLAN
SHEET 1 OF 3	ELECTRIC SUBSTRUCTURE DRAWING UNDERGROUND INSTALLAT

	SHT. REF	DESCRIPTION
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	SHEET 3 OF 3	ELECTRIC SUBSTRUCTURE DRAWING UNDERGROUND INSTALLATION
	AT&T-1	AT&T CONDUIT PLAN
	AT&T-2	AT&T CONDUIT PLAN
	AT&T-3	AT&T CONDUIT PLAN
	AT&T-4	AT&T CONDUIT PLAN
	AT&T-5	AT&T CONDUIT PLAN
	AT&T-6	AT&T CONDUIT PLAN
	CATV-1	COMCAST CONDUIT PLAN
	CATV-2	COMCAST CONDUIT PLAN
	CATV-3	COMCAST CONDUIT PLAN
	CATV-4	COMCAST CONDUIT PLAN
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	W-10345-01	RECYCLED WATER 8" PVC (DRY) - PIPE INSTALLATION
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_	W-10345-05	RECYCLED WATER - PROJECT DETAILS
_	W-10345-06	RECYCLED WATER - PROJECT DETAILS
	W-10345-07	RECYCLED WATER - PROJECT DETAILS
_		

CAUTION:

HIGH PRESSURE GAS LINES WITH IN PROJECT LIMITS (HPF)

EXISTING 8" HPF PARALLEL WITH MARIN AVENUE ALONG NORTH SIDE

EXISTING 12" HPF ALONG CENTER LINE OF KAINS AVENUE

EXISTING 20" HPF ALONG EAST SIDE OF CORNELL AVENUE

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DESIGNED BY: J. YOUNG

DRAWN BY: J. YOUNG CHECKED BY:

REVIEWED BY: R. STEVENS DATE: JANUARY 20, 2017



Engineers / Surveyors / Planners 322 HARBOUR WAY, STE 23 RICHMOND, CA 94801 PH: (510) 529-0336 FAX: (510) 529-0336

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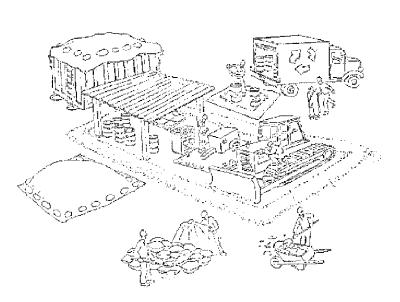
SHEET	INDEX

SUBMITTAL (01/20/2017)

CONSTRUCTION

DWG No. (CIVIL SHEETS ONLY) C - 2.022 **02** OF

Pollution Prevention - It's Part of the Plan



Runoff from streets and other paved areas is a major source of pollution and damage to creeks and the San Francisco Bay. Construction activities can directly affect the health of creeks and the Bay unless contractors and crews plan ahead to keep dirt, debris, and other construction waste away from storm drains and local creeks. Following these guidelines and the project specifications will ensure your compliance with County of Alameda requirements.

Make sure your crews and subs do the job right!

Materials storage & spill cleanup

Non-hazardous materials management

- ✓ Sand, dirt, and similar materials must be stored at least 10 feet (3 meters) from catch basins. All construction material must be covered with a tarp and contained with a perimeter control during wet weather or when rain is forecasted or when not actively being used within 14 days.
- ✓ Use (but don't overuse) reclaimed water for dust control as needed.
- ✓ Sweep or vacuum streets and other paved areas daily. Do not wash down streets or work areas with water!
- ✓ Recycle all asphalt, concrete, and aggregate base material from demolition activities. Comply with Alameda County Ordinances for recycling construction materials, wood, gyp board, pipe, etc.
- ✓ Check dumpsters regularly for leaks and to make sure they are not overfilled. Repair or replace leaking dumpsters promptly.
- Cover all dumpsters with a tarp at the end of every work day or during wet weather.

Hazardous materials management

- ✓ Label all hazardous materials and hazardous wastes (such as pesticides, paints, thinners, solvents, fuel, oil, and antifreeze) in accordance with city, county, state, and federal regulations.
- ✓ Store hazardous materials and wastes in water tight containers, store in appropriate secondary containment, and cover them at the end of every work day or during wet weather or when rain is forecasted.
- ► Follow manufacturer's application instructions for hazardous materials and be careful not to use more than necessary. Do not apply chemicals outdoors when rain is forecasted within 24 hours.
- ✓ Be sure to arrange for appropriate disposal of all hazardous wastes.

Spill prevention and control

- Keep a stockpile of spill cleanup materials (rags, absorbents, etc.) available at the construction site at all times.
- When spills or leaks occur, contain them immediately and be particularly careful to prevent leaks and spills from reaching the gutter, street, or storm drain. Never wash spilled material into a gutter, street, storm drain, or creek!
- Dispose of all containment and cleanup materials properly.
- Report any hazardous materials spills immediately! Dial 911 or Alameda County Public Works Agency dispatch at (510) 670-5500

Construction Entrances and Perimeter

- Establish and maintain effective perimeter controls and stabilize all construction entrances and exits to sufficiently control erosion and sediment discharges from site and tracking off site.
- ✓ Sweep or vacuum any street tracking immediately and secure sediment source to prevent further tracking.

Vehicle and equipment maintenance & cleaning

- ✓ Inspect vehicles and equipment for leaks
- frequently. Use drip pans to catch leaks until repairs are made; repair leaks
- Fuel and maintain vehicles on site only in a bermed area or over a drip pan that

is big enough to prevent runoff.

- ✓ If you must clean vehicles or equipment on site, clean with water only in a bermed area that will not allow
- rinse water to run into gutters, streets, storm drains, or creeks.
- ✓ Do not clean vehicles or equipment on-site using soaps, solvents, degreasers, steam cleaning equipment, etc.

Earthwork & contaminated soils

- ✓ Keep excavated soil on the site where it will not collect in the street.
- ✓ Transfer to dump trucks should take place on the site, not in the street.
- ✓ Use fiber rolls, silt fences, or other control measures to minimize the flow of silt off the site.



- ✓ Earth moving activities are only allowed during dry weather by permit and as approved by the County Inspector in the Field.
- ✓ Mature vegetation is the best form of erosion control. Minimize disturbance to existing vegetation whenever possible. ✓ If you disturb a slope during construction, prevent erosion by securing the soil with erosion control fabric, or seed with fast-

growing grasses as soon as possible. Place

fiber rolls down-slope until soil is secure.

✓ If you suspect contamination (from site history, discoloration, odor, texture, abandoned underground tanks or pipes, or buried debris), call the Engineer for help in determining what should be done, and manage disposal of cntaminated soil according to their instructions.

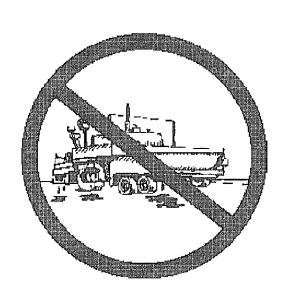
Dewatering operations

- ✓ Effectively manage all run-on, all runoff within the site, and all runoff that discharges from the site. Run-on from off site shall be directed away from all disturbed areas or shall collectively be in compliance.
- ✓ Reuse water for dust control, irrigation, or another on-site purpose to the greatest extent possible.
- ▶ Be sure to notify and obtain approval from the Engineer before discharging water to a street, gutter, or storm drain. Filtration or diversion through a basin, tank, or sediment trap may be required.
- ✓ In areas of known contamination, testing is required prior to reuse or discharge of groundwater. Consult with the Engineer to determine what testing is required and how to interpret results Contaminated groundwater must be treated or hauled off-site for proper disposal.

Saw cutting

- ✓ Always completely cover or barricade storm drain inlets when saw cutting. Use
- filter fabric, catch basin inlet filters, or sand/gravel bags to keep slurry out of the storm drain system.
- ✓ Shovel, absorb, or vacuum saw-cut slurry and pick up all waste as soon as you are finished in one location or at the end of each work day (whichever is sooner!).
- ✓ If saw cut slurry enters a catch basin, clean it up immediately.


Paving/asphalt work



- Always cover storm drain inlets and manholes when paving or applying seal coat, tack coat, slurry seal, or fog seal.
- ✓ Protect gutters, ditches, and drainage courses
- with sand/gravel bags, or earthen berms.
- ✓ Do not sweep or wash down excess sand from sand sealing into gutters, storm drains, or creeks. Collect sand and return it to the stockpile, or dispose of it as trash.
- ✓ Do not use water to wash down fresh asphalt concrete pavement.

Concrete, grout, and mortar storage & waste disposal

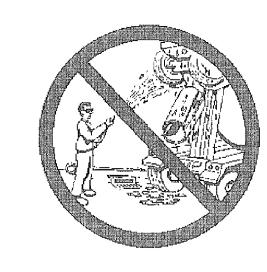- ✓ Store concrete, grout, and mortar under cover, on pallets, and away from drainage areas. These materials must never reach a storm drain.
- ✓ Wash out concrete equipment/trucks off-site or into contained washout areas that will not allow discharge of wash water onto the underlying soil or onto the surrounding areas.



✓ Collect the wash water from washing exposed aggregate concrete and remove it for appropriate disposal off site.

Painting

- ✓ Never rinse paint brushes o materials in a gutter or street! ✓ Paint out excess water-based paint before rinsing brushes rollers, or containers in a sink.
- ✓ Paint out excess oil-based paint before cleaning brushes in thinner.
- Filter paint thinners and solvents for reuse whenever possible. Dispose of oil-based paint sludge and unusable thinner as hazardous waste.

Landscape Materials

- ✓ Contain, cover, and store on pallets all stockpiled landscape materials (mulch, compost, fertilizers, etc.) during wet weather or when rain is forecasted or when not actively being used within 14 days.
- ✓ Discontinue the application of any erodible landscape material within 2 days of forecasted rain and during wet weather.

Storm drain polluters may be liable for fines of \$10,000 or more per day!

For references and more detailed information: www.cleanwaterprogram.org www.cabmphandbooks.com

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DESIGNED BY: J. YOUNG DRAWN BY: J. YOUNG CHECKED BY:

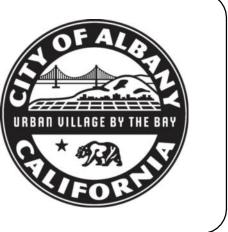
J. WHITE REVIEWED BY: R. STEVENS JANUARY 20, 2017



REGISTRATION:



MARK HURLEY, CITY OF ALBANY ENGINEER HAS REVIEWED AND APPROVED THE PLANS FOR GENERAL CONFORMANCE WITH THE CITY OF ALBANY STANDARD SPECIFICATIONS AND ORDINANCES



City of Albany

MARIN UTILITY UNDERGROUNDING, RECYCLED WATER PIPELINE, AND THE BUCHANAN MARIN BIKEWAY PHASE III PROJECT

POLLUTION PREVENTION

C-2.1

DWG No. (CIVIL SHEETS ONLY) 03 22 OF

CONSTRUCTION

- CONTRACTOR SHALL BE HELD RESPONSIBLE FOR ANY AND ALL DAMAGE TO EXISTING STRUCTURES AND/OR UTILITIES DURING CONSTRUCTION. PROPER REPAIR SHALL BE DONE TO THE SATISFACTION OF THE ENGINEER AND THE RESPECTIVE UTILITY COMPANY.
- 5. ALL PIPELINES AND OTHER UNDERGROUND FACILITIES MAY NOT BE SHOWN. EXISTING UNDERGROUND FACILITIES AS SHOWN ARE APPROXIMATE ONLY AND WERE OBTAINED FROM AVAILABLE UTILITY RECORDS. HOWEVER, THE CITY OF ALBANY ASSUMES NO RESPONSIBILITY FOR THEIR ACCURACY OR COMPLETENESS. IT SHALL BE THE CONTRACTOR'S RESPONSIBILITY TO CONTACT ALL UTILITIES AND TO HAVE ALL FACILITIES LOCATED IN THE FIELD PRIOR TO THE START OF ANY CONSTRUCTION. THE CONTRACTOR SHALL CONTACT UNDERGROUND SERVICE ALERT AT 1-800-227-2600 AT LEAST TWO WORKING DAYS PRIOR TO EXCAVATION.
- SLOPES OF ALL EMBANKMENT FILL SHALL BE 2:1 (HORIZONTAL: VERTICAL) UNLESS OTHERWISE NOTED ON PLANS OR AS DIRECTED BY THE ENGINEER. SLOPES OF ALL EMBANKMENT CUTS SHALL BE 3:1 (HORIZONTAL:VERTICAL) UNLESS OTHERWISE NOTED ON THE PLANS OR AS DIRECTED BY THE ENGINEER. ATTENTION IS DIRECTED TO CALTRANS STANDARD SPECIFICATIONS, SECTION 19, FOR EMBANKMENT CONSTRUCTIONS WHERE APPLICABLE.
- 7. SEE SPECIFICATIONS FOR DETAILS NOT SHOWN HEREIN.
- 8. ALL POLES, VALVES, BOXES WITHIN THE PROJECT AREA WILL BE REMOVED, RELOCATED, OR ADJUSTED TO GRADE OF NEW IMPROVEMENTS AS SHOWN ON THE PLANS AND AS DIRECTED BY THE ENGINEER.
- THE CONTRACTOR SHALL NOT PERFORM WORK OUTSIDE THE PROJECT LIMIT.
- 10. THE CONTRACTOR SHALL POST EMERGENCY TELEPHONE NUMBERS FOR POLICE, FIRE, AMBULANCE, AND THOSE AGENCIES RESPONSIBLE FOR MAINTENANCE OF UTILITIES IN THE VICINITY OF JOBSITE.
- 11. THE GENERAL CONTRACTOR IS RESPONSIBLE FOR COORDINATING ALL OF THE WORK PERFORMED BY HIS SUBCONTRACTORS, WITHOUT EXCEPTION.
- 12. THE CONTRACTOR SHALL IDENTIFY A RESPONSIBLE CONTACT PERSON, WHO IS AN EMPLOYEE OF THE CONTRACTOR, AND A 24-HOUR TELEPHONE NUMBER TO CALL TO RESOLVE PROBLEMS WITH NOISE, DUST OR OTHER CONSTRUCTION-RELATED ISSUES. THIS SIGN SHALL BE APPROVED BY THE CITY IS REPRESENTATIVE PRIOR TO CONSTRUCTION.
- 13. THE CONTRACTOR SHALL BE REQUIRED TO KEEP ALL CONSTRUCTION ACTIVITIES WITHIN THE RIGHTS-OF-WAY AND EASEMENTS OBTAINED FOR THIS PROJECT UNLESS OTHERWISE SHOWN. THIS SHALL INCLUDE, BUT NOT BE LIMITED TO, VEHICLES AND EQUIPMENT, LIMITS OF TRENCH EXCAVATIONS, AND STOCKPILED NEW MATERIAL.
- 14. THE CONTRACTOR SHALL PROVIDE PROTECTION DEVICES INCLUDING BARRICADES, FENCING, WARNING SIGNS, LIGHTS, FLAGGERS OR OTHER ITEMS NECESSARY TO ENSURE PUBLIC SAFETY WITHIN THE PROJECT SITE. THIS REQUIREMENT SHALL APPLY CONTINUOUSLY AND NOT BE LIMITED TO NORMAL WORKING HOURS.
- 15. CONTRACTOR SHALL EXERCISE DUE CAUTION DURING CONSTRUCTION TO PROTECT ANY EXISTING LANDSCAPING, FIXTURES, EQUIPMENT, CONCRETE SIDEWALK, CONCRETE DRIVEWAY, CONCRETE CURB & GUTTER, AND AC PAVING TO REMAIN. ANY DAMAGE RESULTING FROM CONTRACTOR OPERATIONS SHALL BE REPAIRED AS DIRECTED BY THE CITY'S REPRESENTATIVE, AT NO ADDITIONAL COST TO THE CITY.
- 16. PER CITY OF ALBANY MONUMENT PRESERVATION POLICY, EXISTING SURVEY MONUMENTS SHALL BE PRESERVED, REFERENCED, OR REPLACED BY THE CONTRACTOR. A COPY OF THE CURRENT CITY POLICY ON MONUMENT PRESERVATION WILL BE PROVIDED IN THE STANDARD SPECIFICATIONS FOR THIS PROJECT. THE CONTRACTOR SHALL FOLLOW SPECIFIED POLICY. CONTRACTOR SHALL CONFORM TO THE CITY OF ALBANY MONUMENT PRESERVATION POLICY AND PRESERVE ALL SURVEY MARKERS AND MONUMENTATION. THE CONTRACTOR SHALL NOTIFY THE CITY ENGINEER OF ANY EXISTING FEDERAL, STATE, COUNTY, AND PRIVATE LAND SURVEY MARKER REQUIRING RESETTING.
- 17. CONSTRUCTION ACTIVITY SHALL BE RESTRICTED TO THE HOURS OF 8:00 AM TO 6:00 PM, MONDAY THROUGH SATURDAYS AND 10:00 AM TO 6:00 PM SUNDAYS AND LEGAL HOLIDAYS, UNLESS OTHERWISE APPROVED IN WRITING BY THE CITY ENGINEER
- 18. DUST SHALL BE CONTROLLED AND ADJOINING STREET AND PRIVATE DRIVES SHALL BE KEPT CLEAN OF PROJECT DIRT, MUD, MATERIALS AND DEBRIS. TO THE SATISFACTION OF THE COMMUNITY DEVELOPMENT DIRECTOR.

APPROVAL / COORDINATION NOTES

- 1. THE CONTRACTOR SHALL CONTACT "UNDERGROUND SERVICE ALERT AT 1-(800) 227-2600 AT LEAST 5 DAYS PRIOR TO CONSTRUCTION AND 48 HOURS PRIOR TO ANY EXCAVATION.
- IT IS THE RESPONSIBILITY OF THE CONTRACTOR TO OBTAIN ALL PERMITS NECESSARY TO PERFORM THE WORK SHOWN IN THESE PLANS FROM THE APPROPRIATE AGENCIES, PRIOR TO PERFORMING ANY WORK.
- 3. THE CONTRACTOR SHALL COMPLY WITH ALL LOCAL SOUND CONTROL AND NOISE LEVEL RULES, REGULATION AND ORDINANCES WHICH APPLY TO ANY WORK PERFORMED UNDER THE CONTRACT. EACH INTERNAL COMBUSTION ENGINE USED ON THE PROJECT SHALL BE EQUIPPED WITH A MUFFLER RECOMMENDED BY THE MANUFACTURER. NO INTERNAL COMBUSTION ENGINE SHALL BE OPERATED ON THE PROJECT WITHOUT SAID MUFFLER. NOISE LEVELS SHALL BE KEPT TO THE SATISFACTION OF THE CITY ENGINEER.
- 4. ALL WORK SHALL CONFORM TO THE CITY OF ALBANY STANDARD SPECIFICATIONS DATED DECEMBER 2015, THE CITY OF ALBANY STANDARD DETAILS, AND THE 2010 CALTRANS STANDARD SPECIFICATIONS WHEN REFERENCED.
- 5. COORDINATE ALL WORK INVOLVING UTILITIES WITH THE APPROPRIATE UTILITY COMPANY.
- PROVIDE TEMPORARY SIGNS, CONES BARRICADES AND ADVANCE WARNING SIGNS PER CALTRANS REQUIREMENTS.
- 7. OBSTRUCTIONS INDICATED ARE FOR INFORMATION ONLY. IT IS THE CONTRACTOR'S RESPONSIBILITY TO VERIFY THE LOCATION AND DEPTH WITH THE APPROPRIATE AGENCIES. CALL (800) 642-2444, A MINIMUM OF 48 HOURS PRIOR TO ANY CONSTRUCTION.
- CONTRACTOR SHALL EXPOSE ALL POTENTIAL UTILITY CONFLICT CROSSINGS AS WELL AS CONNECTION POINTS TO EXISTING UTILITIES. HE SHALL COORDINATE WITH ENGINEER TO LOCATE AND VERIFY DEPTHS. ENGINEER SHALL THEN MAKE ANY REVISIONS TO HIS DESIGN PRIOR TO CONSTRUCTION. ALL REVISIONS MUST BE APPROVED BY THE CITY OF ALBANY PUBLIC WORKS
- 9. MAINTAIN ONE TEN-FOOT TRAFFIC LANE IN EACH DIRECTION IN PUBLIC STREETS AT ALL TIMES DURING WORKING HOURS OR PROVIDE FLAGGERS PER CALTRANS REQUIREMENTS.
- 10. THE CONTRACTOR SHALL SUBMIT A TRAFFIC CONTROL PLAN FOR APPROVAL PRIOR TO STARTING ANY WORK IN THE PUBLIC STREETS.
- 11. NO OPEN EXCAVATION SHALL BE LEFT UNSUPERVISED AT ANY TIME.
- 12. PRUNING OF TREE ROOTS & BRANCHES SHALL BE APPROVED IN ADVANCE AS DIRECTED BY THE CITY.

TREE PROTECTION NOTES

- 1. ARBORIST: CONTRACTOR SHALL MAKE PROVISIONS IN HIS BID TO RETAIN A LICENSED CERTIFIED, CITY APPROVED ARBORIST FOR "ON-CALL" CONSULTATION DURING CONSTRUCTION. NO EQUIPMENT SHALL BE PERMITTED ON-SITE UNTIL THE ARBORIST HAS APPROVED THE PROPOSED STAGING AREA(S). NO TREE PRUNING, REMOVAL OR ROOT-CUTTING SHALL OCCUR WITHOUT THE ARBORIST DIRECTION, RECOMMENDATIONS OR APPROVAL.
- 2. TRENCHING: ALL TRENCHING WITHIN THE DRIP LINE OF EXISTING TREES SHALL BE BY HAND WITH CARE TAKEN NOT TO DAMAGE ROOTS OVER 2" DIAMETER.
- 3. ADVANCE MARKING: CONTRACTOR'S ARBORIST SHALL MARK LIMITS OF AREA WITHIN DRIP LINES IN ADVANCE PRIOR TO EXCAVATION.
- 4. PRUNING: TREES SHALL BE PRUNED ONLY AS RECOMMENDED BY CONTRACTORS ARBORIST.
- 5. CONSTRUCTION OPERATIONS: NO CONSTRUCTION OPERATIONS SHALL BE CARRIED ON WITHIN THE DRIP LINE AREA OF ANY TREE DESIGNATED TO BE SAVED EXCEPT AS AUTHORIZED BY THE CONTRACTORS ARBORIST.
- 6. STORAGE: THE AREA UNDER THE DRIP LINE OF THE TREE SHALL BE KEPT CLEAN. NO CONSTRUCTION MATERIALS NOR CHEMICAL SOLVENTS SHALL BE STORED OR DUMPED
- 7. TREE DAMAGE: ANY DAMAGE OF EXISTING TREE CROWNS OR ROOT SYSTEMS SHALL BE REPAIRED IMMEDIATELY BY AN APPROVED TREE SURGEON UNDER THE DIRECTION OF THE CONTRACTORS ARBORIST

SURFACE RESTORATION NOTES

- 1. ALL PAVEMENT CUTS SHALL BE SAWCUT, SMOOTH AND VERTICAL. THE PAVEMENT AREA BEING REMOVED SHALL BE RECTANGULAR, UNLESS SHOWN OTHERWISE ON PLANS.
- 2. CONTRACTOR SHALL RESTORE ALL EXISTING PRIVATE AND PUBLIC IMPROVEMENTS TO THEIR EXISTING CONDITION OR BETTER. THIS INCLUDES, BUT IS NOT LIMITED TO ALL LANDSCAPING, IRRIGATION, DRIVEWAYS, AC PAVING, CONCRETE WORK AND UTILITIES UNLESS NOTED OR DIRECTED OTHERWISE BY THE CITY'S REPRESENTATIVE.
- 3. RIMS OF EXISTING UTILITY BOXES AND OTHER RELATED APPURTENANCES THAT ARE TO REMAIN SHALL BE PROTECTED DURING CONSTRUCTION AND SHALL BE ADJUSTED TO FINISH GRADES TO MAINTAIN ACCESSIBLE PATH. ANY DAMAGE RESULTING TO EXISTING UTILITY FACILITIES FROM CONTRACTOR OPERATIONS SHALL BE REPAIRED AS DIRECTED BY THE APPROPRIATE AGENCY AT NO ADDITIONAL COST TO THE CITY OR UTILITY OWNER.
- 4. ALL MANHOLES. VALVES AND MONUMENT FRAMES SHALL BE SET TO FINISH GRADE AFTER/DURING PAVING AND TO MAINTAIN ACCESSIBLE PATH.
- 5. PROVIDE SMOOTH CONFORM TO EXISTING AC PAVEMENT

LEGEND

APPLICABLE STANDARD PLANS

CITY OF ALBANY STANDARD PLANS WITH SPECIAL PROVISIONS

ST-1 AC DIKE, CURB AND GUTTER DETAIL

ST-2 DRIVEWAY TYPE 1

ST-4 SIDEWALK: TYPE 1 AND 2

ST-5 CURB AND SIDEWALK JOINTS

ST-8 LEGEND AND NOTES - SIDEWALK, DRIVEWAY AND CURB AND GUTTER

ST-9.1 CURB RAMP DETAILS (CASE A)

ST-9.8 CURB RAMP DETAILS (CASE G)

ST-9.10 CURB RAMP DETAILS - GROOVING AND DOMES

CURB, GUTTER & SIDEWALK REPAIRS

ST-11 STREET & TRAFFIC SIGN MOUNTING STANDARDS

ST-12 SIGN ANCHOR DETAIL

ST-13 TRENCH SURFACE RESTORATION DETAIL

ST-17 NPDES MEDALLION

**LIST NOT ALL INCLUSIVE

EXISTING - RIGHT OF WAY LINE

G	GAS LINE
——Е——	ELECTRICAL LINE
——— SD ———	STORM DRAIN LINE
SS	SANITARY SEWER LINE
——т—	TELEPHONE LINE (AT&T)
w	DOMESTIC WATER LINE
xx	CHAIN LINK FENCE
	VERTICAL CURB
	CONCRETE CURB AND GUTTER
M	UTILITY MANHOLE
(STORM DRAIN MANHOLE
S	SANITARY SEWER MANHOLE
\bigcirc	TELEPHONE MANHOLE
-	JOINT POLE
EB□	ELECTRICAL BOX
	GUY WIRE
CO°	SANITARY SEWER CLEANOUT
WM□	WATER METER
WV⊛	WATER VALVE
FH+O+	FIRE HYDRANT
GV⊛	GAS VALVE
\$ \$	ELECTROLIER

TREE WITH DIAMETER

VEHICLE SIGNAL FACE

PEDESTRIAN HEAD

ABBREVIATIONS

DDIVE	VIATIONO
В	AGGREGATE BASE
C	ASPHALT CONCRETE
T&T	AMERICAN TELEPHONE & TELEGRAPH
WG	AMERICAN WIRE GAUGE
?	BEGINNING OF CURVE
- -Р	BACKFLOW PREVENTOR
VC	BEGINNING OF VERTICAL CURVE
N	BACK OF SIDEWALK
&G	CURB AND GUTTER
A	CALIFORNIA
В	CATCH BASIN
L, C/L	CENTER LINE
LF	CHAIN LINK FENCE
0	CLEANOUT
OA	COUNTY OF ALAMEDA
ONC	CONCRETE
R	CURB RETURN
H	DETECTOR HANDHOLD
	DRAINAGE INLET
ΙA	DIAMETER
LC	LOOP DETECTOR LEAD-IN CABLE
W	DOMESTIC WATER
WY	DRIVEWAY
WG	DRAWING
	ELECTRIC
3	ELECTRICAL BOX
BMUD	EAST BAY MUNICIPAL UTILITY DISTRICT
2	END OF CURVE
_EV	ELEVATION
>	EDGE OF PAVEMENT
QUIP	EQUIPMENT
SMT	EASEMENT
/	ELECTRICAL
√C	END OF VERTICAL CURVE
/P	EMERGENCY VEHICLE PREEMPTION
Χ	EXISTING
2	FACE OF CURB
<i>)</i> G	FINISHED GRADE
1	FIRE HYDRANT
AWF	FEDERAL HIGHWAY ADMINISTRATION
_	FLOW LINE
3	FINISHED SURFACE
Γ	FOOT/FEET
	GAS LINE

GRADE BREAK

GAS METER

GAS VALVE HOT MIXED ASPHALT HORIZ **HORIZONTAL HIGH POINT** HIGH PRIORITY FACILITY HIGH PRESSURE SODIUM INTERNALLY ILLUMINATES STREET NAME SIGN INVERT GRADE ELEVATION JOINT POLE LENGTH OF CURVE LINEAR FEET LIP OF GUTTER LT LEFT LUMINARIES LUM MAS MAST ARM MOUNTED VEHICLE SIGNAL FACES, SIDE ATTACHMENT MAX MAXIMUM MINIMUM MIN МН **MANHOLE** MON MONUMENT MOUNTING MANUAL ON UNIFORM TRAFFIC CONTROL DEVICES NOT TO SCALE OC ON CENTER **OVERHEAD LINE** PULL BOX PORTLAND CEMENT CONCRETE POINT OF CURVE RETURN PEDESTRIAN PEDESTRIAN PUSH BUTTON PACIFIC GAS AND ELECTRIC COMPANY PROFILE GRADE LINE **PROPOSED** POINT OF REVERSE CURVATURE POLYVINYL CHLORIDE POINT OF VERTICAL INTERSECTION

SS SANITARY SEWER SHT SHEET SIC SIGNAL INTERCONNECT CABLE SIG SIGNAL SSMH SANITARY SEWER MANHOLE SW, S/W SIDEWALK STA STATION STND STANDARD **TELEPHONE** TC TOP OF CURB TRAFFIC CONTROL BOX TCB TOU TIME OF USE TSB TRAFFIC SIGNAL BOX TWO WAY LEFT TURN LANE **TWLTL** TYP TYPICAL UB UTILITY BOX UPRR UNION PACIFIC RAILROAD UTILITY RELOCATION UTILITY

SHOULDER

SHDLR

STORM DRAIN MANHOLE

VERTICAL CURVE VITRIFIED CLAY PIPE VEH VEHICLE **VERT** VERTICAL VAULT VLT WATER WATER METER

WATER VALVE

REINFORCED CONCRETE PIPE RAILROAD

RIGHT ROW, R/W RIGHT OF WAY SLOPE SCHEDULE

STORM DRAIN

CAUTION: HIGH PRESSURE GAS LINES WITH IN PROJECT LIMITS (HPF)

EXISTING 8" HPF PARALLEL WITH MARIN AVENUE ALONG NORTH SIDE EXISTING 12" HPF ALONG CENTER LINE OF KAINS AVENUE EXISTING 20" HPF ALONG EAST SIDE OF CORNELL AVENUE CONTRACTOR TO LOCATE LINE PRIOR TO CONSTRUCTION AND NOTIFY ENGINEER OF ANY CONFLICTS. EXERCISE EXTREME CAUTION WHEN WORKING IN VICINITY OF GAS LINE

L			
	REV	DATE	DESCRIPTION
ſ			
ſ			
7			

DESIGNED BY: J. YOUNG DRAWN BY: J. YOUNG

CHECKED BY: J. WHITE REVIEWED BY: R. STEVENS

JANUARY 20, 2017

No. C 058660

REGISTRATION:

Engineers / Surveyors / Planners 322 HARBOUR WAY, STE 23 RICHMOND, CA 94801 PH: (510) 529-0336 FAX: (510) 529-0336

<<1-+----

MARK HURLEY, CITY OF ALBANY ENGINEER HAS REVIEWED AND APPROVED THE PLANS FOR GENERAL CONFORMANCE WITH THE CITY OF ALBANY STANDARD SPECIFICATIONS AND ORDINANCES




City of Albany


MARIN UTILITY UNDERGROUNDING, RECYCLED WATER PIPELINE, AND THE BUCHANAN MARIN BIKEWAY PHASE III PROJECT


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GENERAL NOTES ABBREVIATIONS & LEGEND STRUCTION

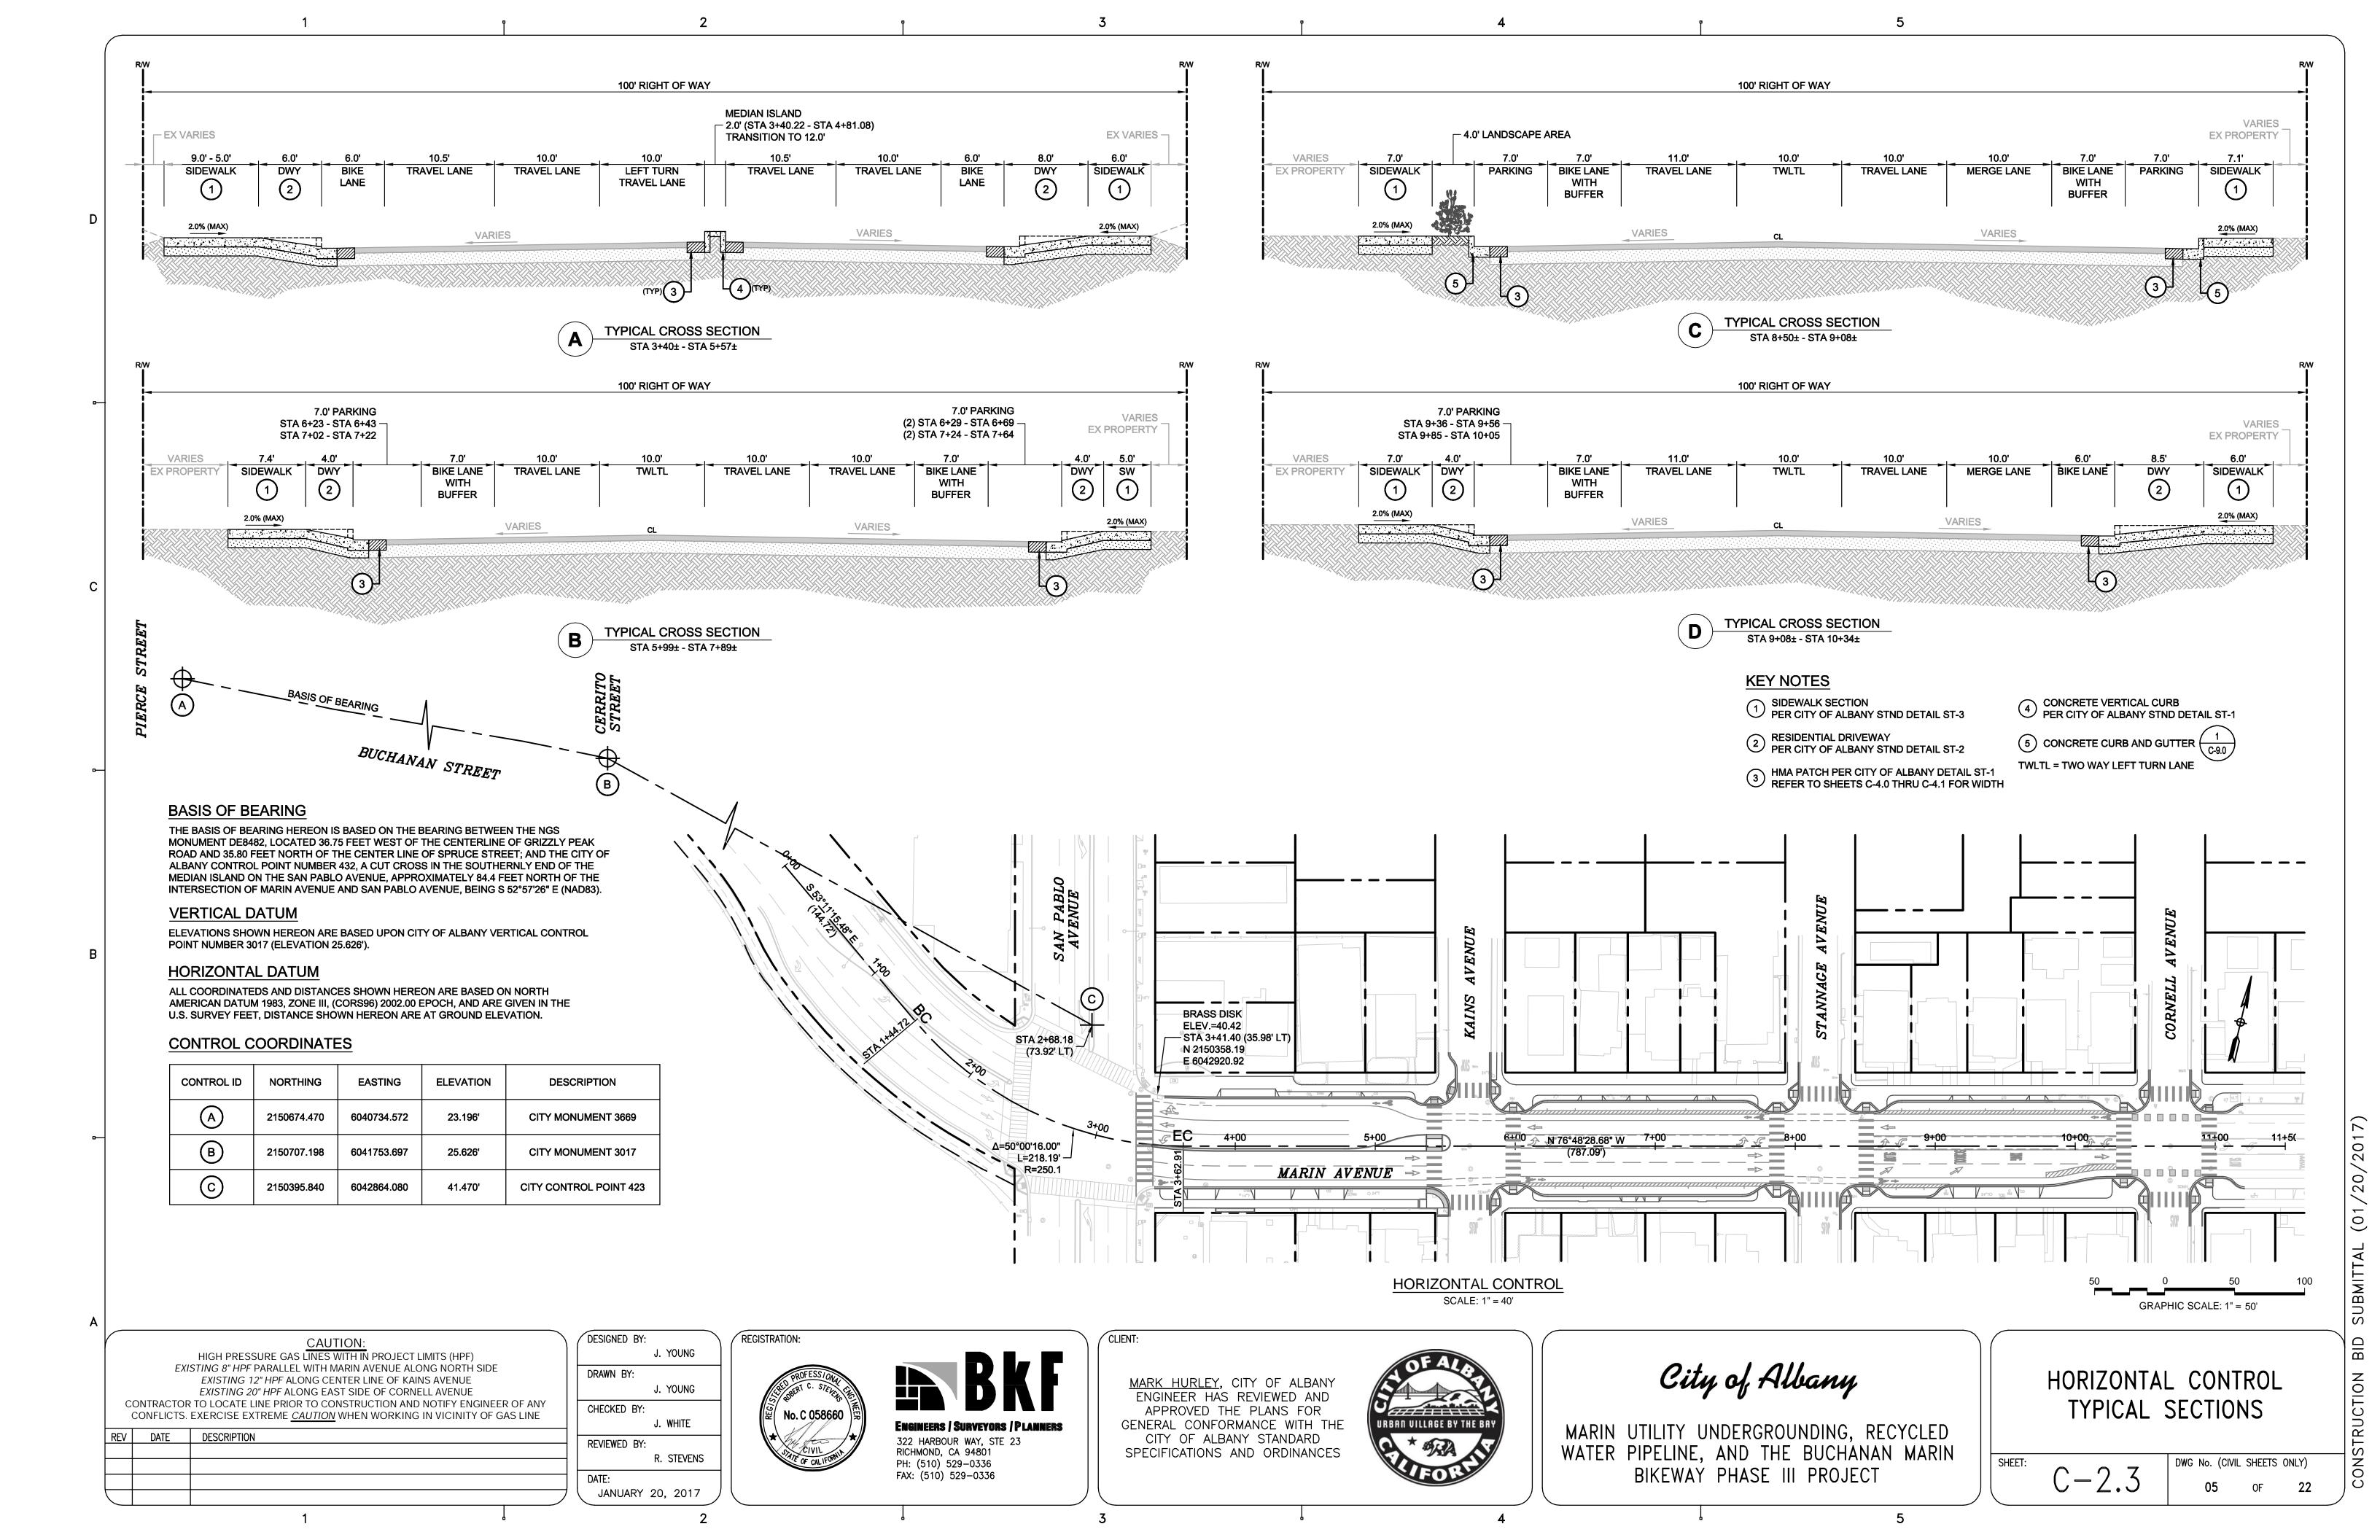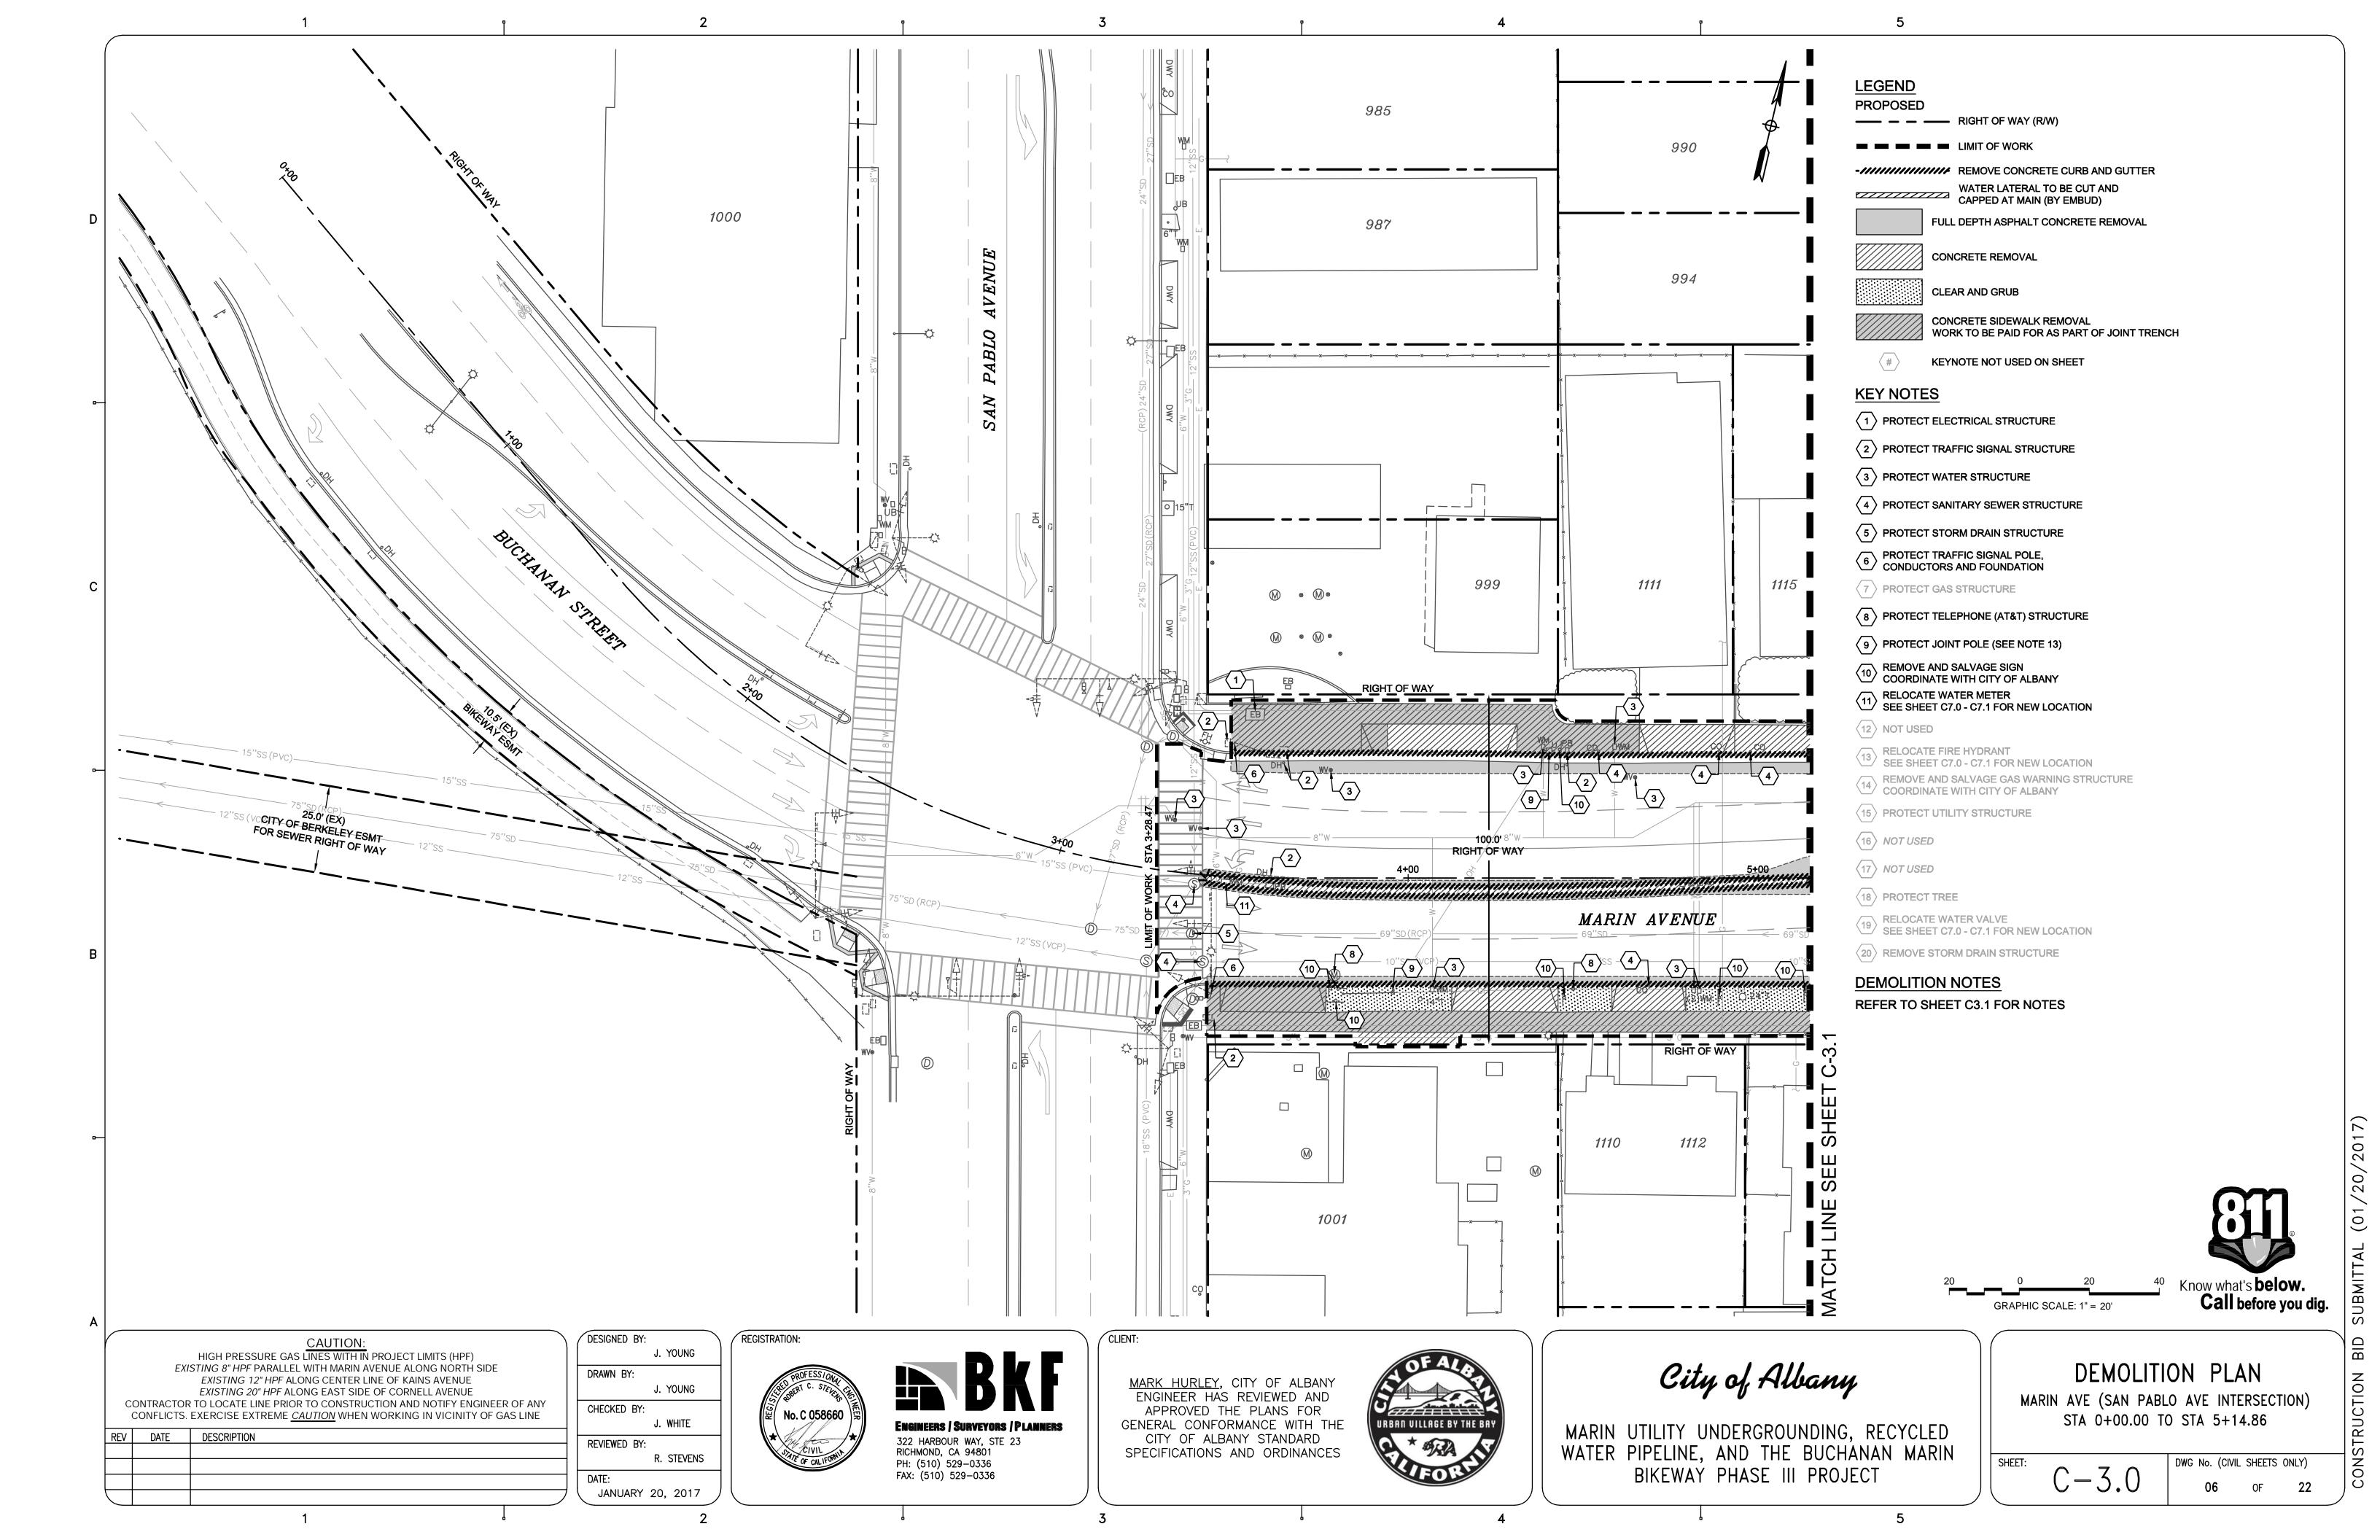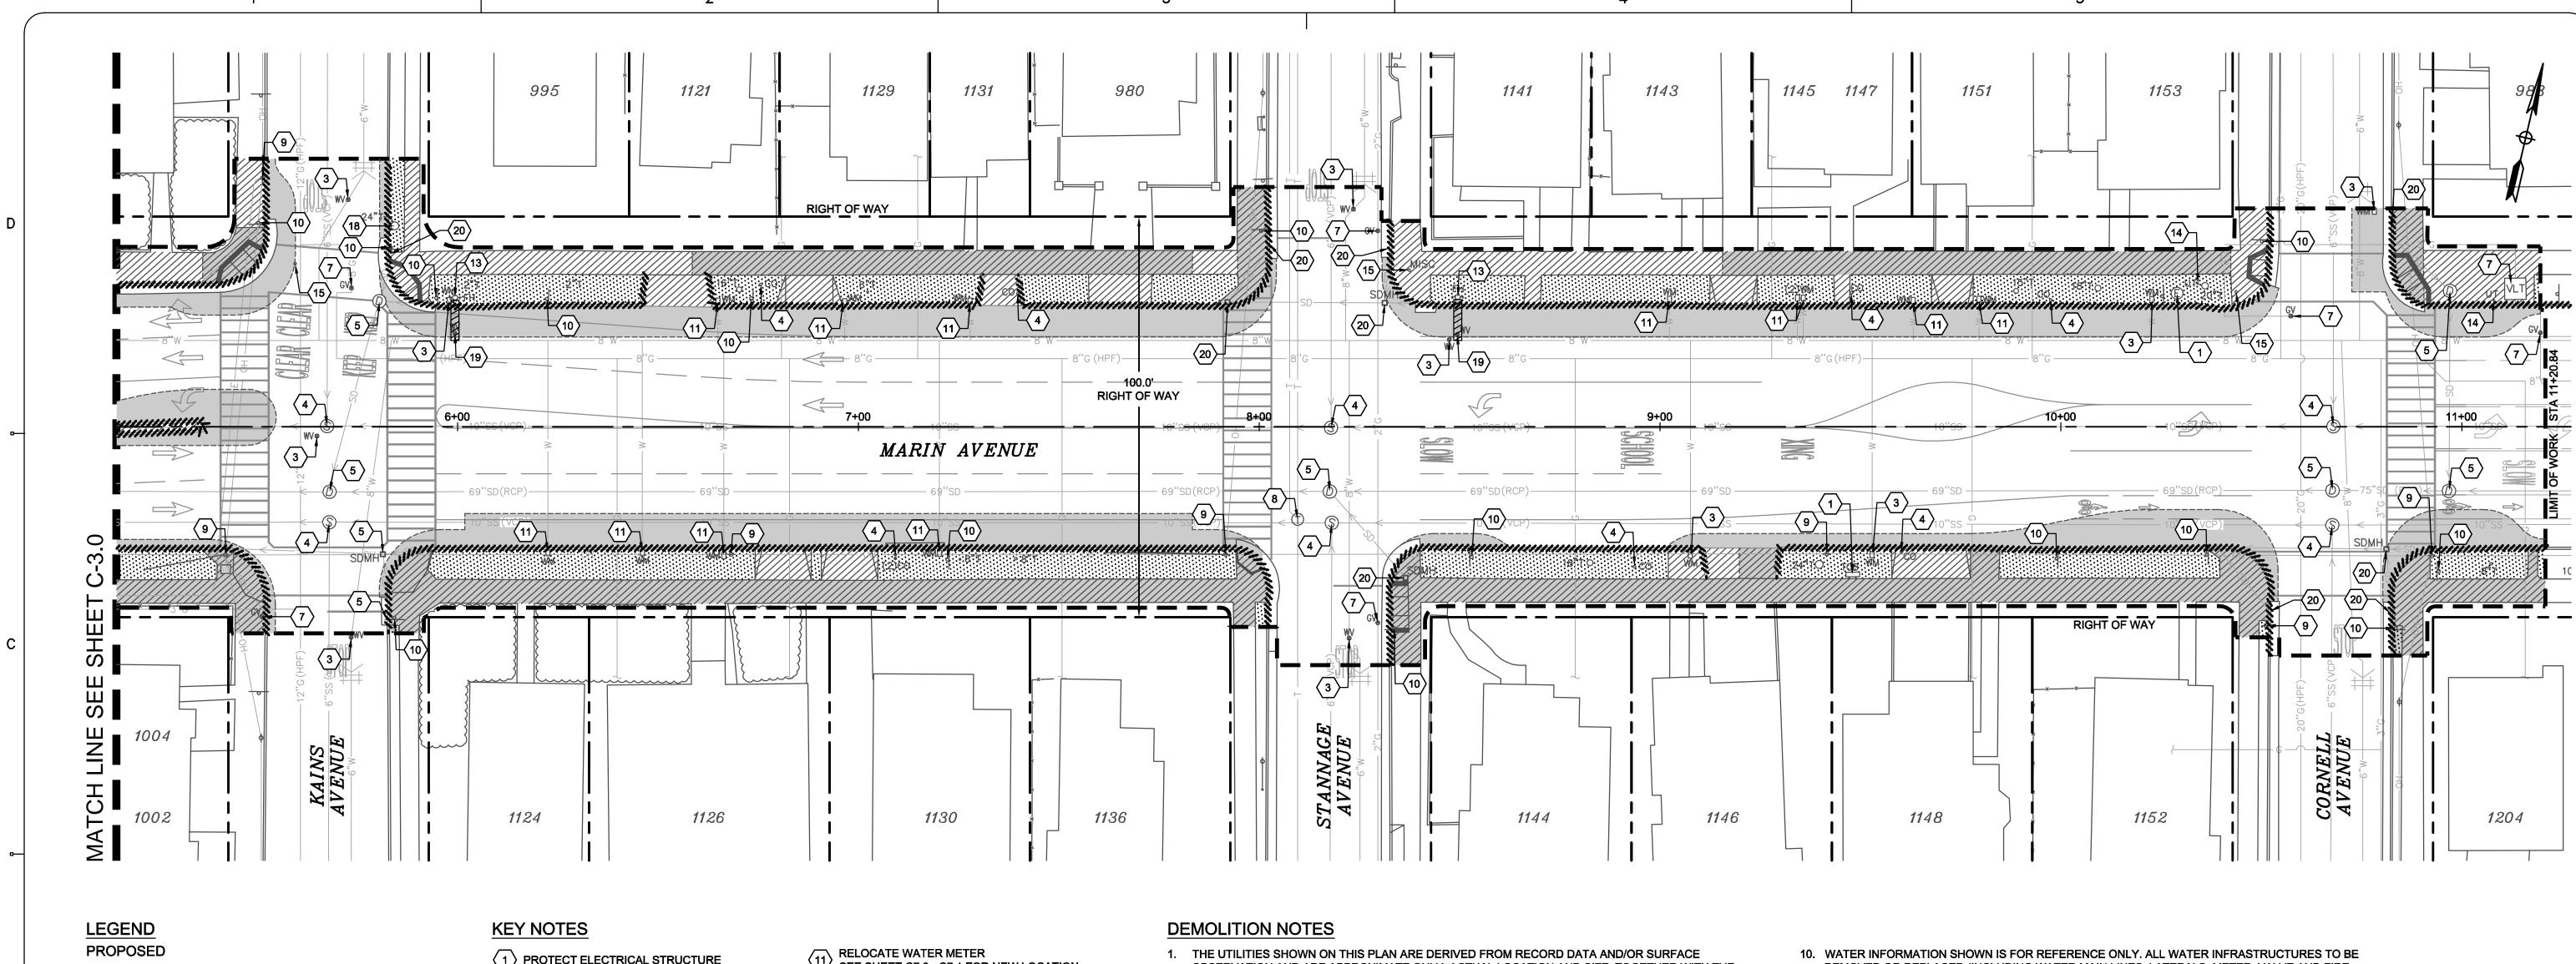DWG No. (CIVIL SHEETS ONLY) C - 2.222 OF







■ ■ ■ LIMIT OF WORK

-//////// REMOVE CONCRETE CURB AND GUTTER

WATER LATERAL TO BE CUT AND CAPPED AT MAIN (BY EMBUD) FULL DEPTH ASPHALT CONCRETE REMOVAL

CLEAR AND GRUB

CONCRETE REMOVAL

CONCRETE SIDEWALK REMOVAL WORK TO BE PAID FOR AS PART OF JOINT TRENCH

KEYNOTE NOT USED ON SHEET

- 1 PROTECT ELECTRICAL STRUCTURE
- 2 PROTECT TRAFFIC SIGNAL STRUCTURE
- (3) PROTECT WATER STRUCTURE
- 4 PROTECT SANITARY SEWER STRUCTURE
- 5 PROTECT STORM DRAIN STRUCTURE
- 6 PROTECT TRAFFIC SIGNAL POLE, CONDUCTORS AND FOUNDATION
- 7 PROTECT GAS STRUCTURE
- 8 PROTECT TELEPHONE (AT&T) STRUCTURE
- 9 PROTECT JOINT POLE (SEE NOTE 13)
- REMOVE AND SALVAGE SIGN COORDINATE WITH CITY OF ALBANY

- RELOCATE FIRE HYDRANT SEE SHEET C7.0 C7.1 FOR NEW LOCATION
- REMOVE AND SALVAGE GAS WARNING STRUCTURE COORDINATE WITH CITY OF ALBANY
- (15) PROTECT UTILITY STRUCTURE
- (16) NOT USED
- (17) NOT USED
- (18) PROTECT TREE
- RELOCATE WATER VALVE
 SEE SHEET C7.0 C7.1 FOR NEW LOCATION
- $\langle 20 \rangle$ REMOVE STORM DRAIN STRUCTURE

- PRESENCE OF ANY ADDITIONAL UTILITY LINES NOT SHOWN ON THIS PLAN SHALL BE VERIFIED BY THE CONTRACTOR IN THE FIELD PRIOR TO CONSTRUCTION.
- 2. CONTRACTOR SHALL PROTECT ALL EXISTING FENCES, WALLS, TREES, PRIVATE LANDSCAPING, CURBS, ABOVEGROUND UTILITIES (JOINT POLES, STREET LIGHTS), AND UNDERGROUND UTILITIES (STORM DRAIN, SANITARY SEWER, WATER AND GAS) UNLESS OTHERWISE NOTED.
- 3. CONTRACTOR SHALL DOCUMENT SURVEY CONTROL POINTS SHOWN ON SHEET C2.2 PRIOR TO BEGINNING OF DEMOLITION.
- 4. ALL EXISTING UTILITY STRUCTURES WITHIN THE LIMIT OF WORK ARE TO BE ADJUSTED TO FINISHED GRADE UNLESS OTHERWISE NOTED.
- 5. CONTRACTOR SHALL PROVIDE CONTINUOUS BICYCLE AND ADA ACCESSIBLE PEDESTRIAN PATHWAYS THROUGHOUT THE PROJECT SITE. ORDER OF WORK WITHIN THE PUBLIC RIGHT OF WAY SHALL BE PHASED SUCH THAT CLOSURE OF PUBLIC FACILITIES ARE MINIMIZED.
- 6. CONTRACTOR TO PROTECT ALL TREES NOT DESIGNATED TO BE REMOVED, INCLUDING BUT NOT LIMITED TO TREES WITHIN AND OUTSIDE OF THE PROJECT LIMITS OF WORK.
- 7. ALL SIDEWALK SAWCUTS, CUT AT THE NEAREST EXPANSION JOINT AS APPROVED BY THE CITY INSPECTOR AND/OR APPROVED REPRESENTATIVE.
- 8. CONTRACTOR IS RESPONSIBLE TO LEGALLY DISPOSE OF ALL REMOVED MATERIAL.
- 9. WITHIN LIMIT OF DEMOLITION DIAMOND GRIND ALL STRIPING AND PAVMENT MARKINGS AS DIRECTED BY ENGINEER.

- HYDRANTS) SHALL BE DONE BY EBMUD. ORIENTATION OF WATER METERS TO BE DETERMINED IN FIELD BY EBMUD.
- 11. FUTURE WATER METERS RELOCATED BY EBMUD (SHOWN ON SHEETS C3.0 THRU C3.1) SHALL BE PROTECTED AND ADJUSTED TO FINISHED GRADE.
- 12. REFER TO LAYOUT PLAN FOR EXACT LIMITS OF DEMOLITION.
- 13. JOINT POLES WITH IN PROJECTS LIMITS SHALL BE PROTECTED AND REMOVED AS PART OF THE BUCHANAN STREET RULE 20 - PHASE 1 PROJECT. REFER TO JOINT TRENCH PLAN SHEETS JT-01 THRU JT-08 FOR MORE DETAILS.

5

14. REFER TO SHEET C2.1 FOR ADDITIONAL GENERAL PROJECT NOTES.

Know what's **below.** Call before you dig. GRAPHIC SCALE: 1" = 20'

CAUTION:

HIGH PRESSURE GAS LINES WITH IN PROJECT LIMITS (HPF) EXISTING 8" HPF PARALLEL WITH MARIN AVENUE ALONG NORTH SIDE EXISTING 12" HPF ALONG CENTER LINE OF KAINS AVENUE EXISTING 20" HPF ALONG EAST SIDE OF CORNELL AVENUE CONTRACTOR TO LOCATE LINE PRIOR TO CONSTRUCTION AND NOTIFY ENGINEER OF ANY CONFLICTS EVED USE EVED ME CALITION WHEN WODEING IN VICINITY OF CAS LINE

	CONFLICTS. EXERCISE EXTREME <u>CAUTION</u> WHEN WORKING IN VICINITY OF GAS LINE			
	REV	DATE	DESCRIPTION	

DESIGNED BY: J. YOUNG

DRAWN BY: J. YOUNG CHECKED BY: J. WHITE REVIEWED BY: R. STEVENS

JANUARY 20, 2017

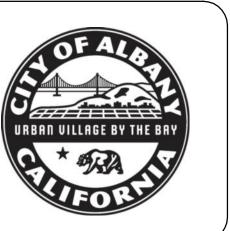


REGISTRATION:

ENGINEERS / SURVEYORS / PLANNERS 322 HARBOUR WAY, STE 23 RICHMOND, CA 94801 PH: (510) 529-0336

FAX: (510) 529-0336

MARK HURLEY, CITY OF ALBANY ENGINEER HAS REVIEWED AND APPROVED THE PLANS FOR GENERAL CONFORMANCE WITH THE CITY OF ALBANY STANDARD SPECIFICATIONS AND ORDINANCES



City of Albany

MARIN UTILITY UNDERGROUNDING, RECYCLED WATER PIPELINE, AND THE BUCHANAN MARIN BIKEWAY PHASE III PROJECT

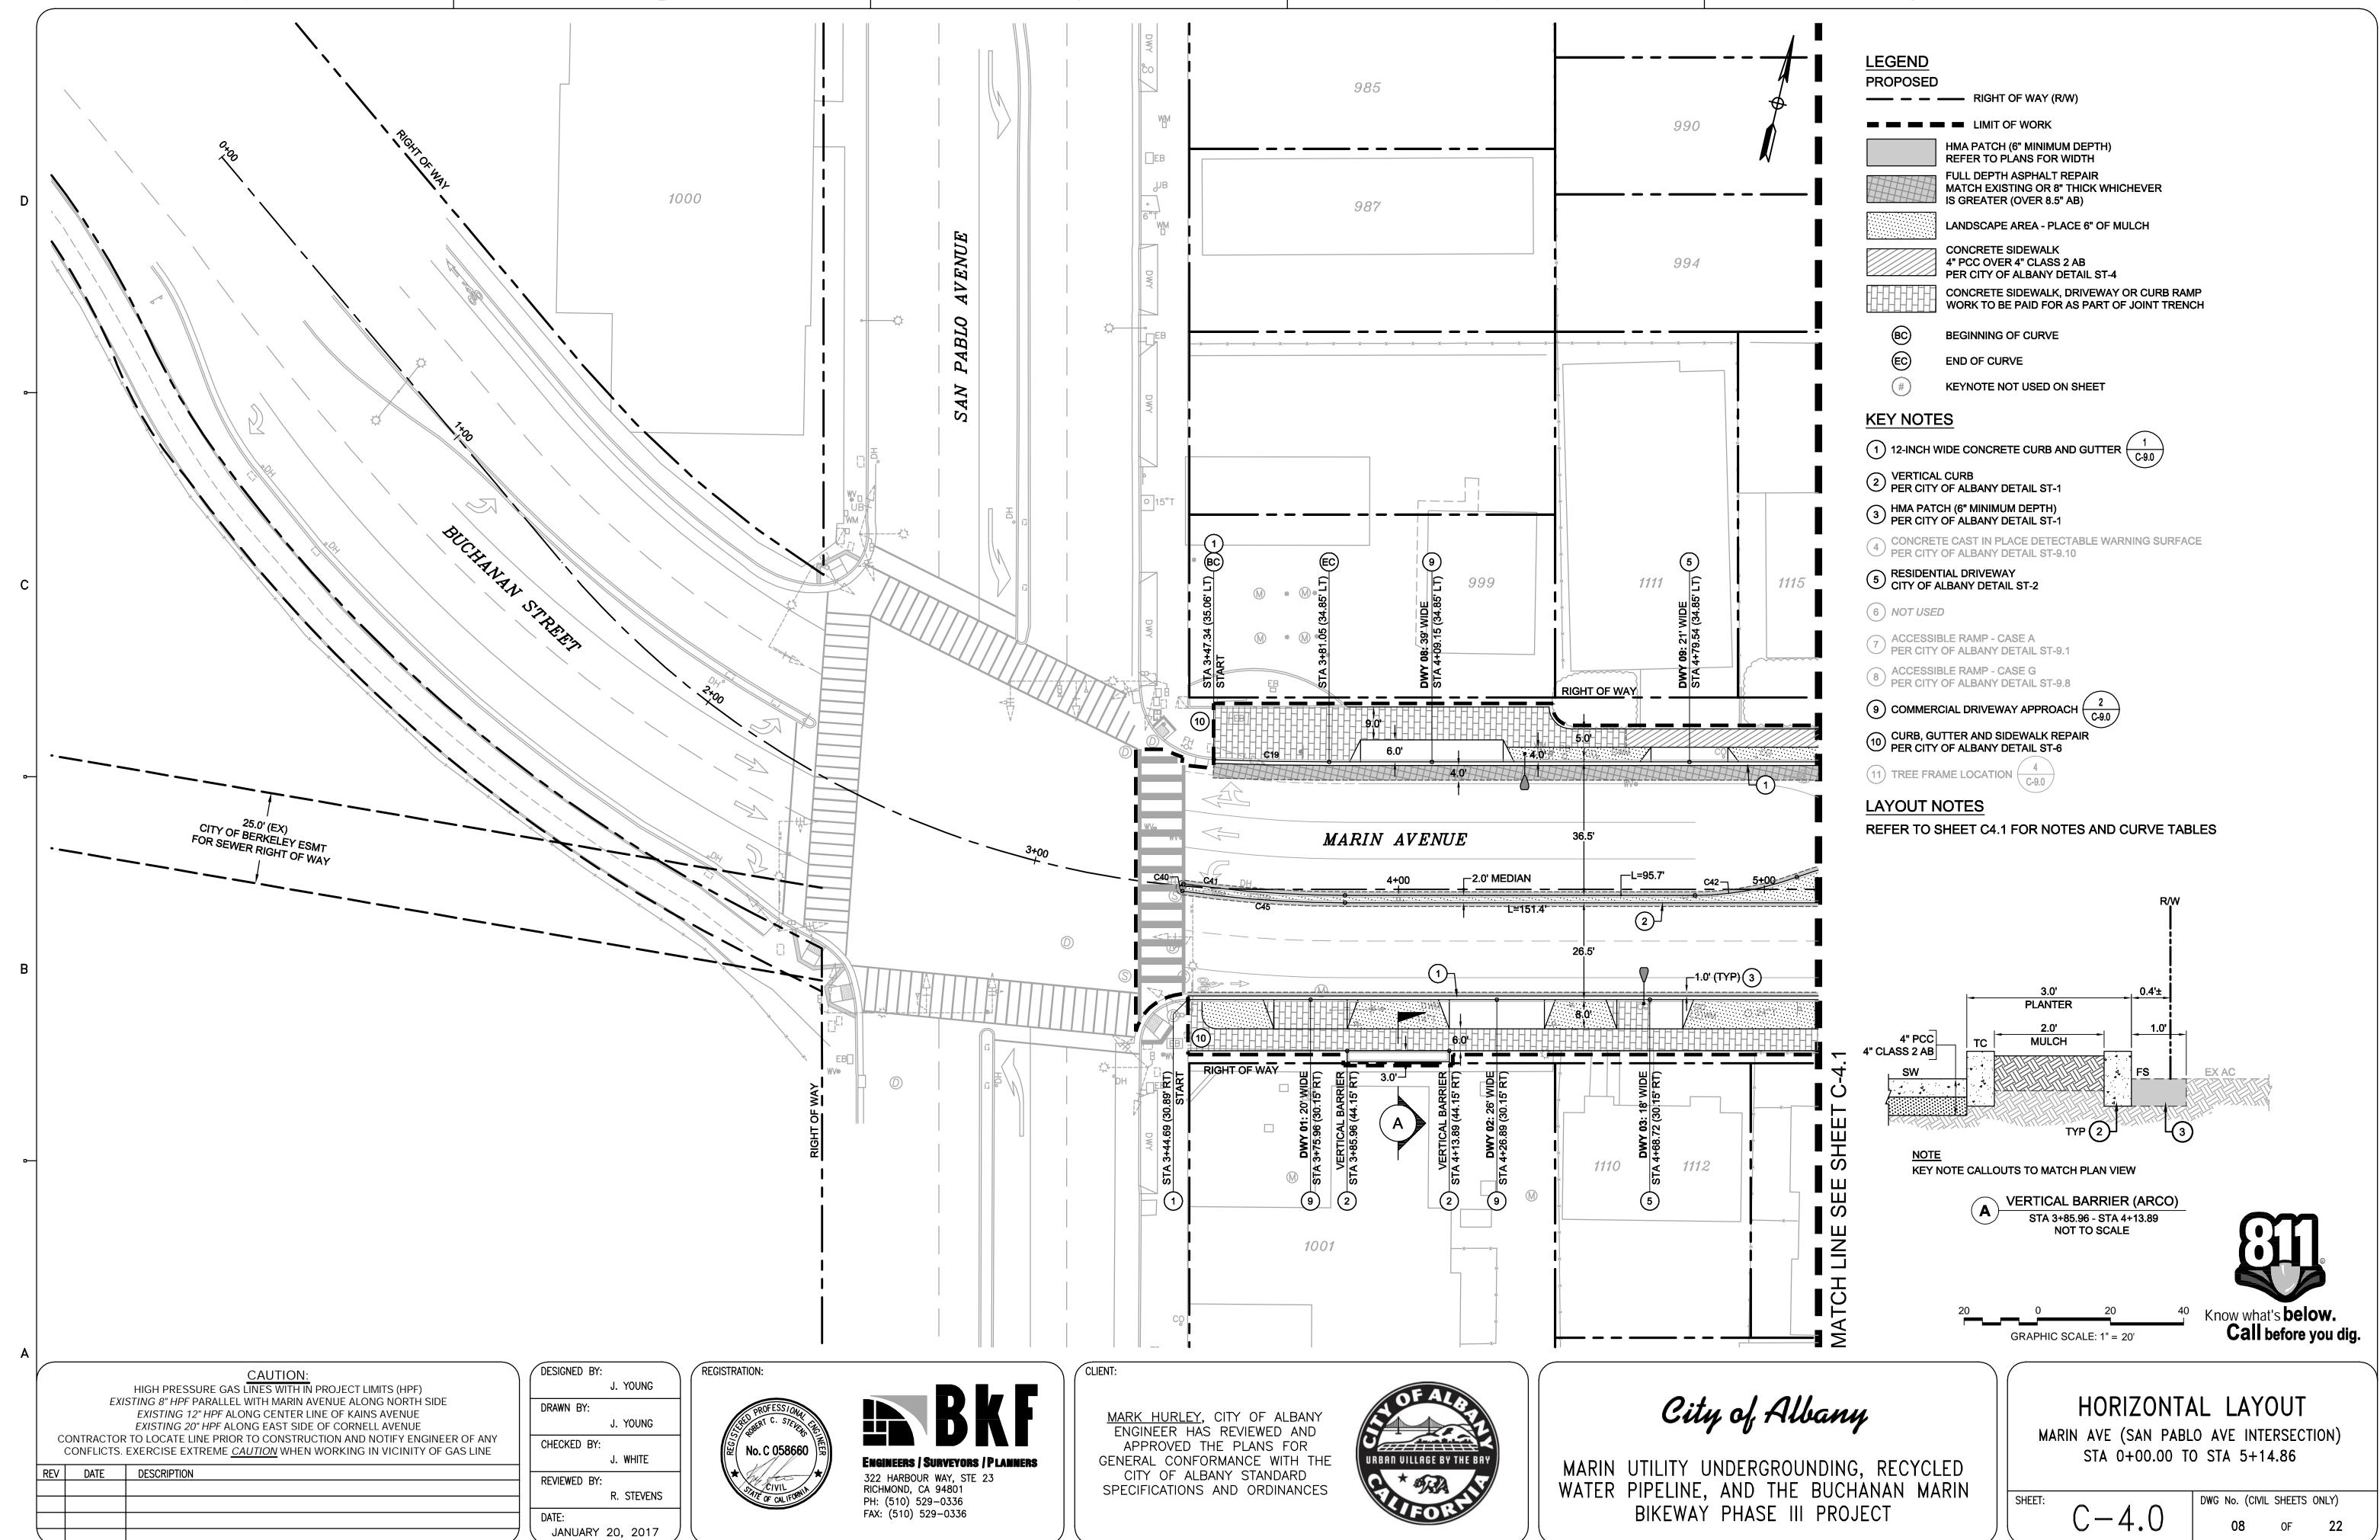
DEMOLITION PLAN

MARIN AVE (KAINS AVE TO CORNELL AVE) STA 5+14.86 TO STA 11+27.32


STRUCTION

DWG No. (CIVIL SHEETS ONLY) C - 3.1OF 22

SHEET:



CONSTRUCTION BID SUBMITTAL (01/20/2

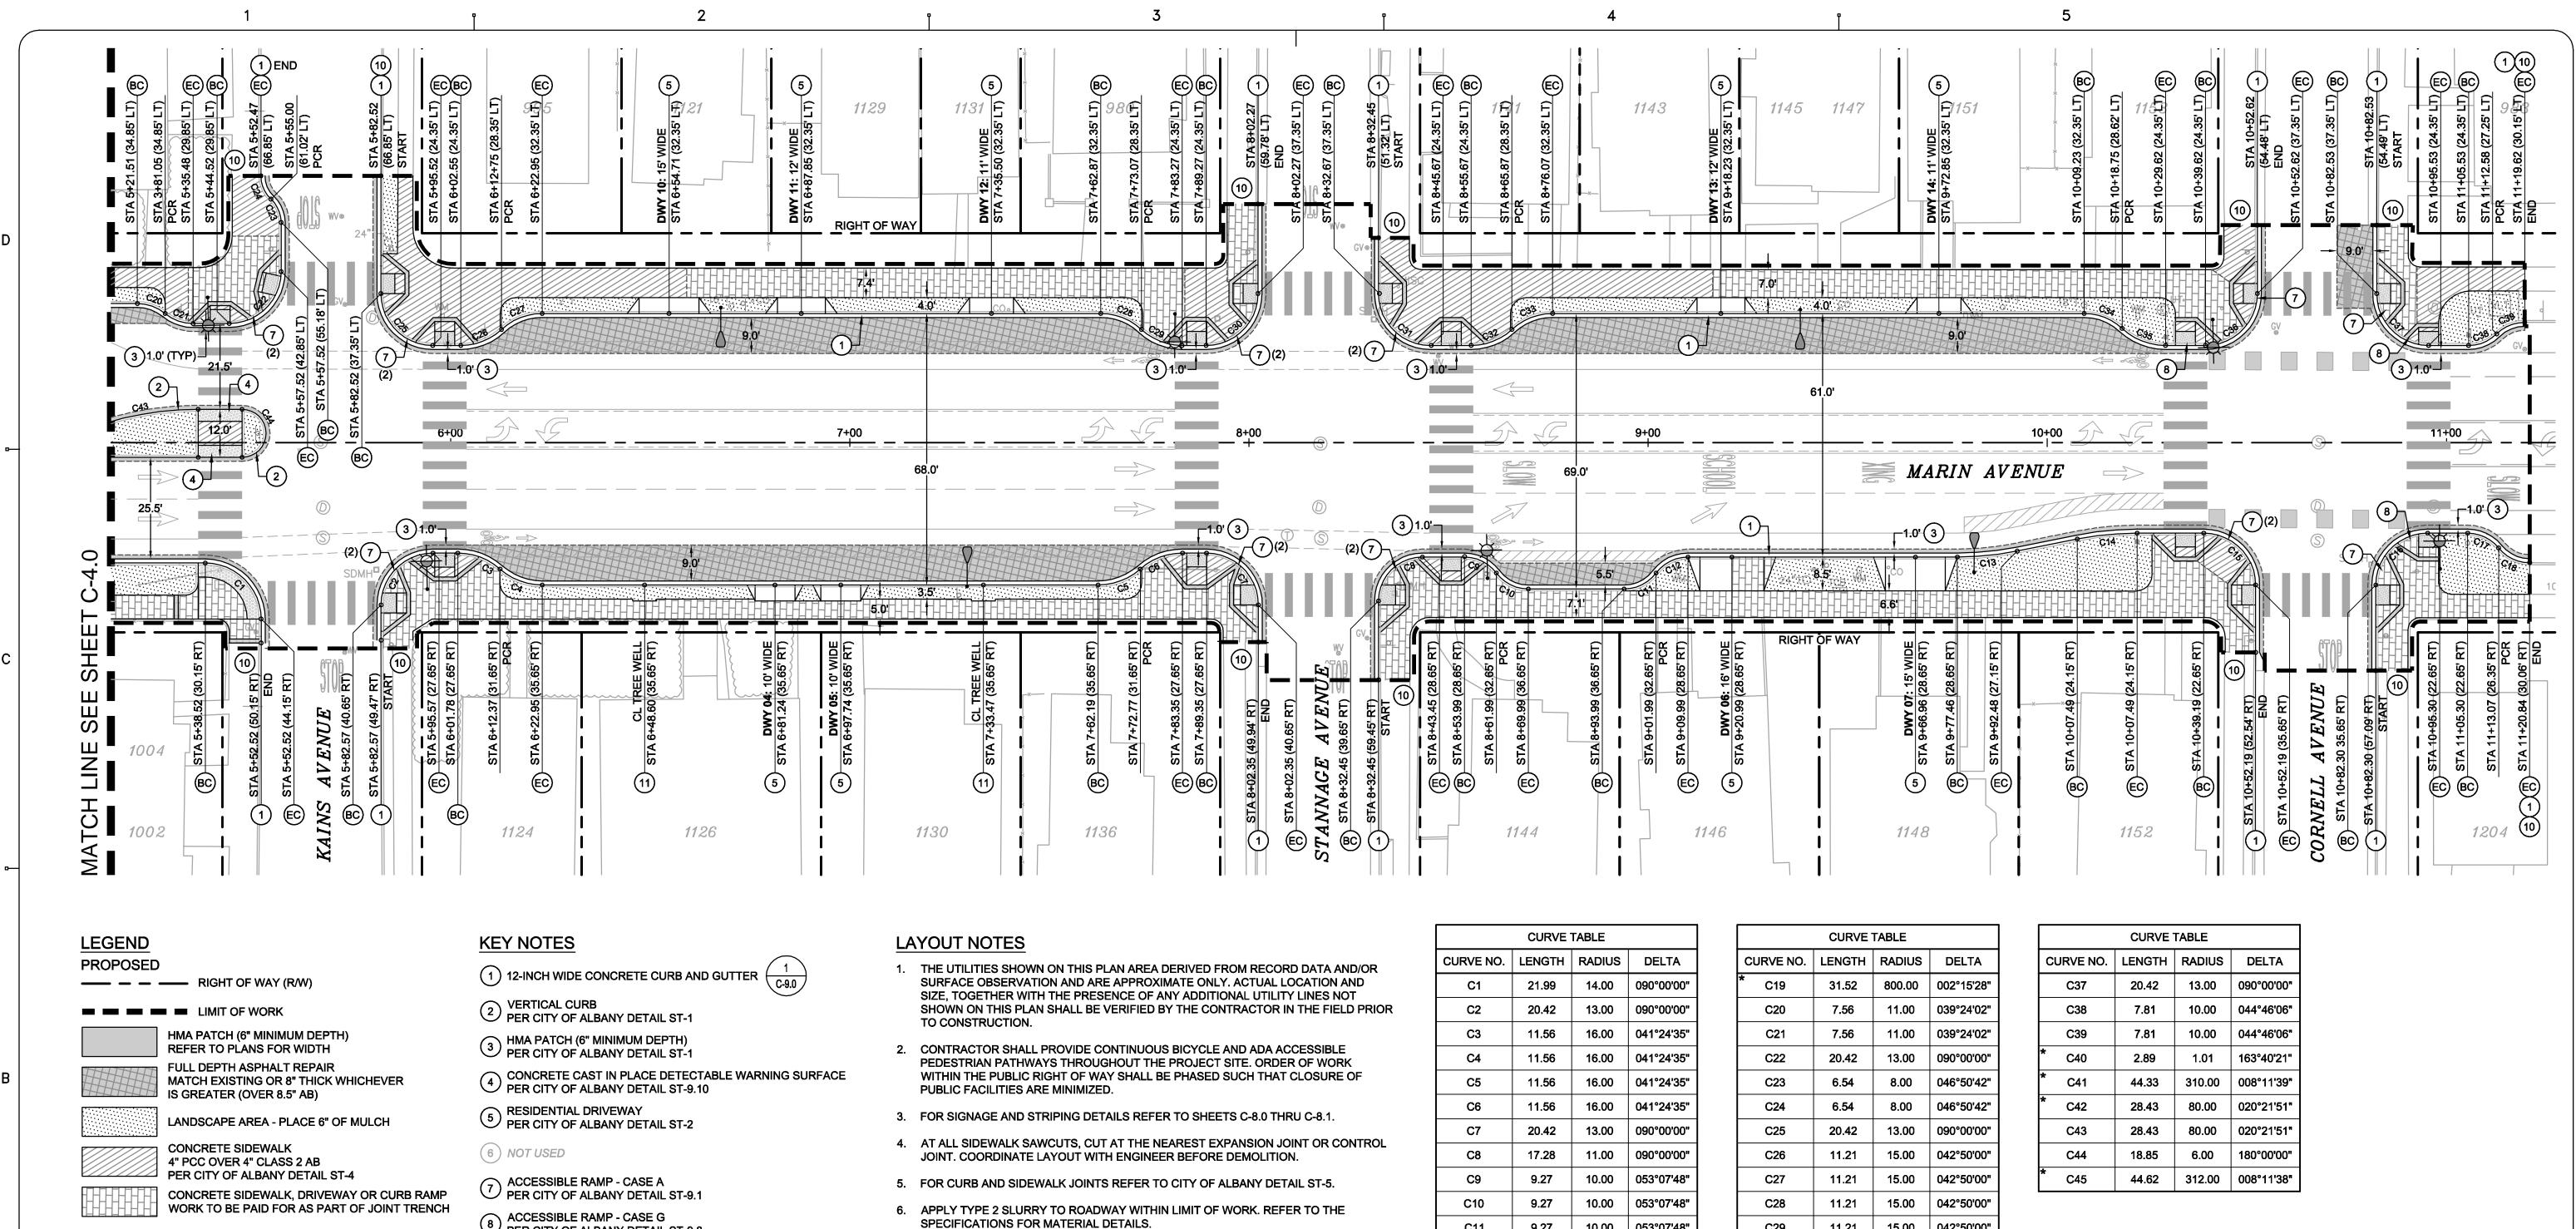

BEGINNING OF CURVE

EC **END OF CURVE KEYNOTE NOT USED ON SHEET** 8 ACCESSIBLE RAMP - CASE G PER CITY OF ALBANY DETAIL ST-9.8

(9) COMMERCIAL DRIVEWAY (-)

CURB, GUTTER AND SIDEWALK REPAIR PER CITY OF ALBANY DETAIL ST-6

11) TREE FRAME LOCATION $\left(\frac{4}{\text{C-9.0}}\right)$

- 7. REFER TO SHEET C9.1 FOR CITY OF ALBANY STANDARD DETAILS.
- 8. REFER TO SHEET C2.2 FOR ADDITIONAL GENERAL PROJECT NOTES.

CURVE TABLE					
CURVE NO.	LENGTH	RADIUS	DELTA		
C1	21.99	14.00	090°00'00"		
C2	20.42	13.00	090°00'00"		
СЗ	11.56	16.00	041°24'35"		
C4	11.56	16.00	041°24'35"		
C5	11.56	16.00	041°24'35"		
C6	11.56	16.00	041°24'35"		
C7	20.42	13.00	090°00'00"		
C8	17.28	11.00	090°00'00"		
C9	9.27	10.00	053°07'48"		
C10	9.27	10.00	053°07'48"		
C11	9.27	10.00	053°07'48"		
C12	9.27	10.00	053°07'48"		
C13	15.11	76.82	011°16'20"		
C14	15.11	76.82	011°16'20"		
C15	20.42	13.00	090°00'00"		
C16	20.42	13.00	090°00'00"		
C17	8.90	10.00	050°59'42"		
C18	8.90	10.00	050°59'42"		
* REFER TO SHEET C4.0					

	CURVE TABLE			
CURVE NO.	LENGTH	RADIUS	DELTA	
* C19	31.52	800.00	002°15'28"	
C20	7.56	11.00	039°24'02"	
C21	7.56	11.00	039°24'02"	
C22	20.42	13.00	090°00'00"	
C23	6.54	8.00	046°50'42"	
C24	6.54	8.00	046°50'42"	
C25	20.42	13.00	090°00'00"	
C26	11.21	15.00	042°50'00"	
C27	11.21	15.00	042°50'00"	
C28	11.21	15.00	042°50'00"	
C29	11.21	15.00	042°50'00"	
C30	20.42	13.00	090°00'00"	
C31	20.42	13.00	090°00'00"	
C32	11.21	15.00	042°50'00"	
C33	11.21	15.00	042°50'00"	
C34	10.47	14.00	042°50'00"	
C35	11.96	16.00	042°50'00"	
C36	20.42	13.00	090°00'00"	



GRAPHIC SCALE: 1" = 20'

SHEET:

5

Know what's **below.** Call before you dig.

STRUCTION

CAUTION: HIGH PRESSURE GAS LINES WITH IN PROJECT LIMITS (HPF) EXISTING 8" HPF PARALLEL WITH MARIN AVENUE ALONG NORTH SIDE EXISTING 12" HPF ALONG CENTER LINE OF KAINS AVENUE EXISTING 20" HPF ALONG EAST SIDE OF CORNELL AVENUE CONTRACTOR TO LOCATE LINE PRIOR TO CONSTRUCTION AND NOTIFY ENGINEER OF ANY

		CONFLICTS. EXERCISE EXTREME $\underline{\textit{CAUTION}}$ WHEN WORKING IN VICINITY OF GAS LINE		
REV DATE I			DESCRIPTION	
	1	01.31.17	ADDENDUM 1	

DESIGNED BY: J. YOUNG

DRAWN BY: J. YOUNG CHECKED BY: J. WHITE REVIEWED BY: R. STEVENS

JANUARY 31, 2017

No. C 058660

REGISTRATION:



MARK HURLEY, CITY OF ALBANY ENGINEER HAS REVIEWED AND APPROVED THE PLANS FOR GENERAL CONFORMANCE WITH THE CITY OF ALBANY STANDARD SPECIFICATIONS AND ORDINANCES



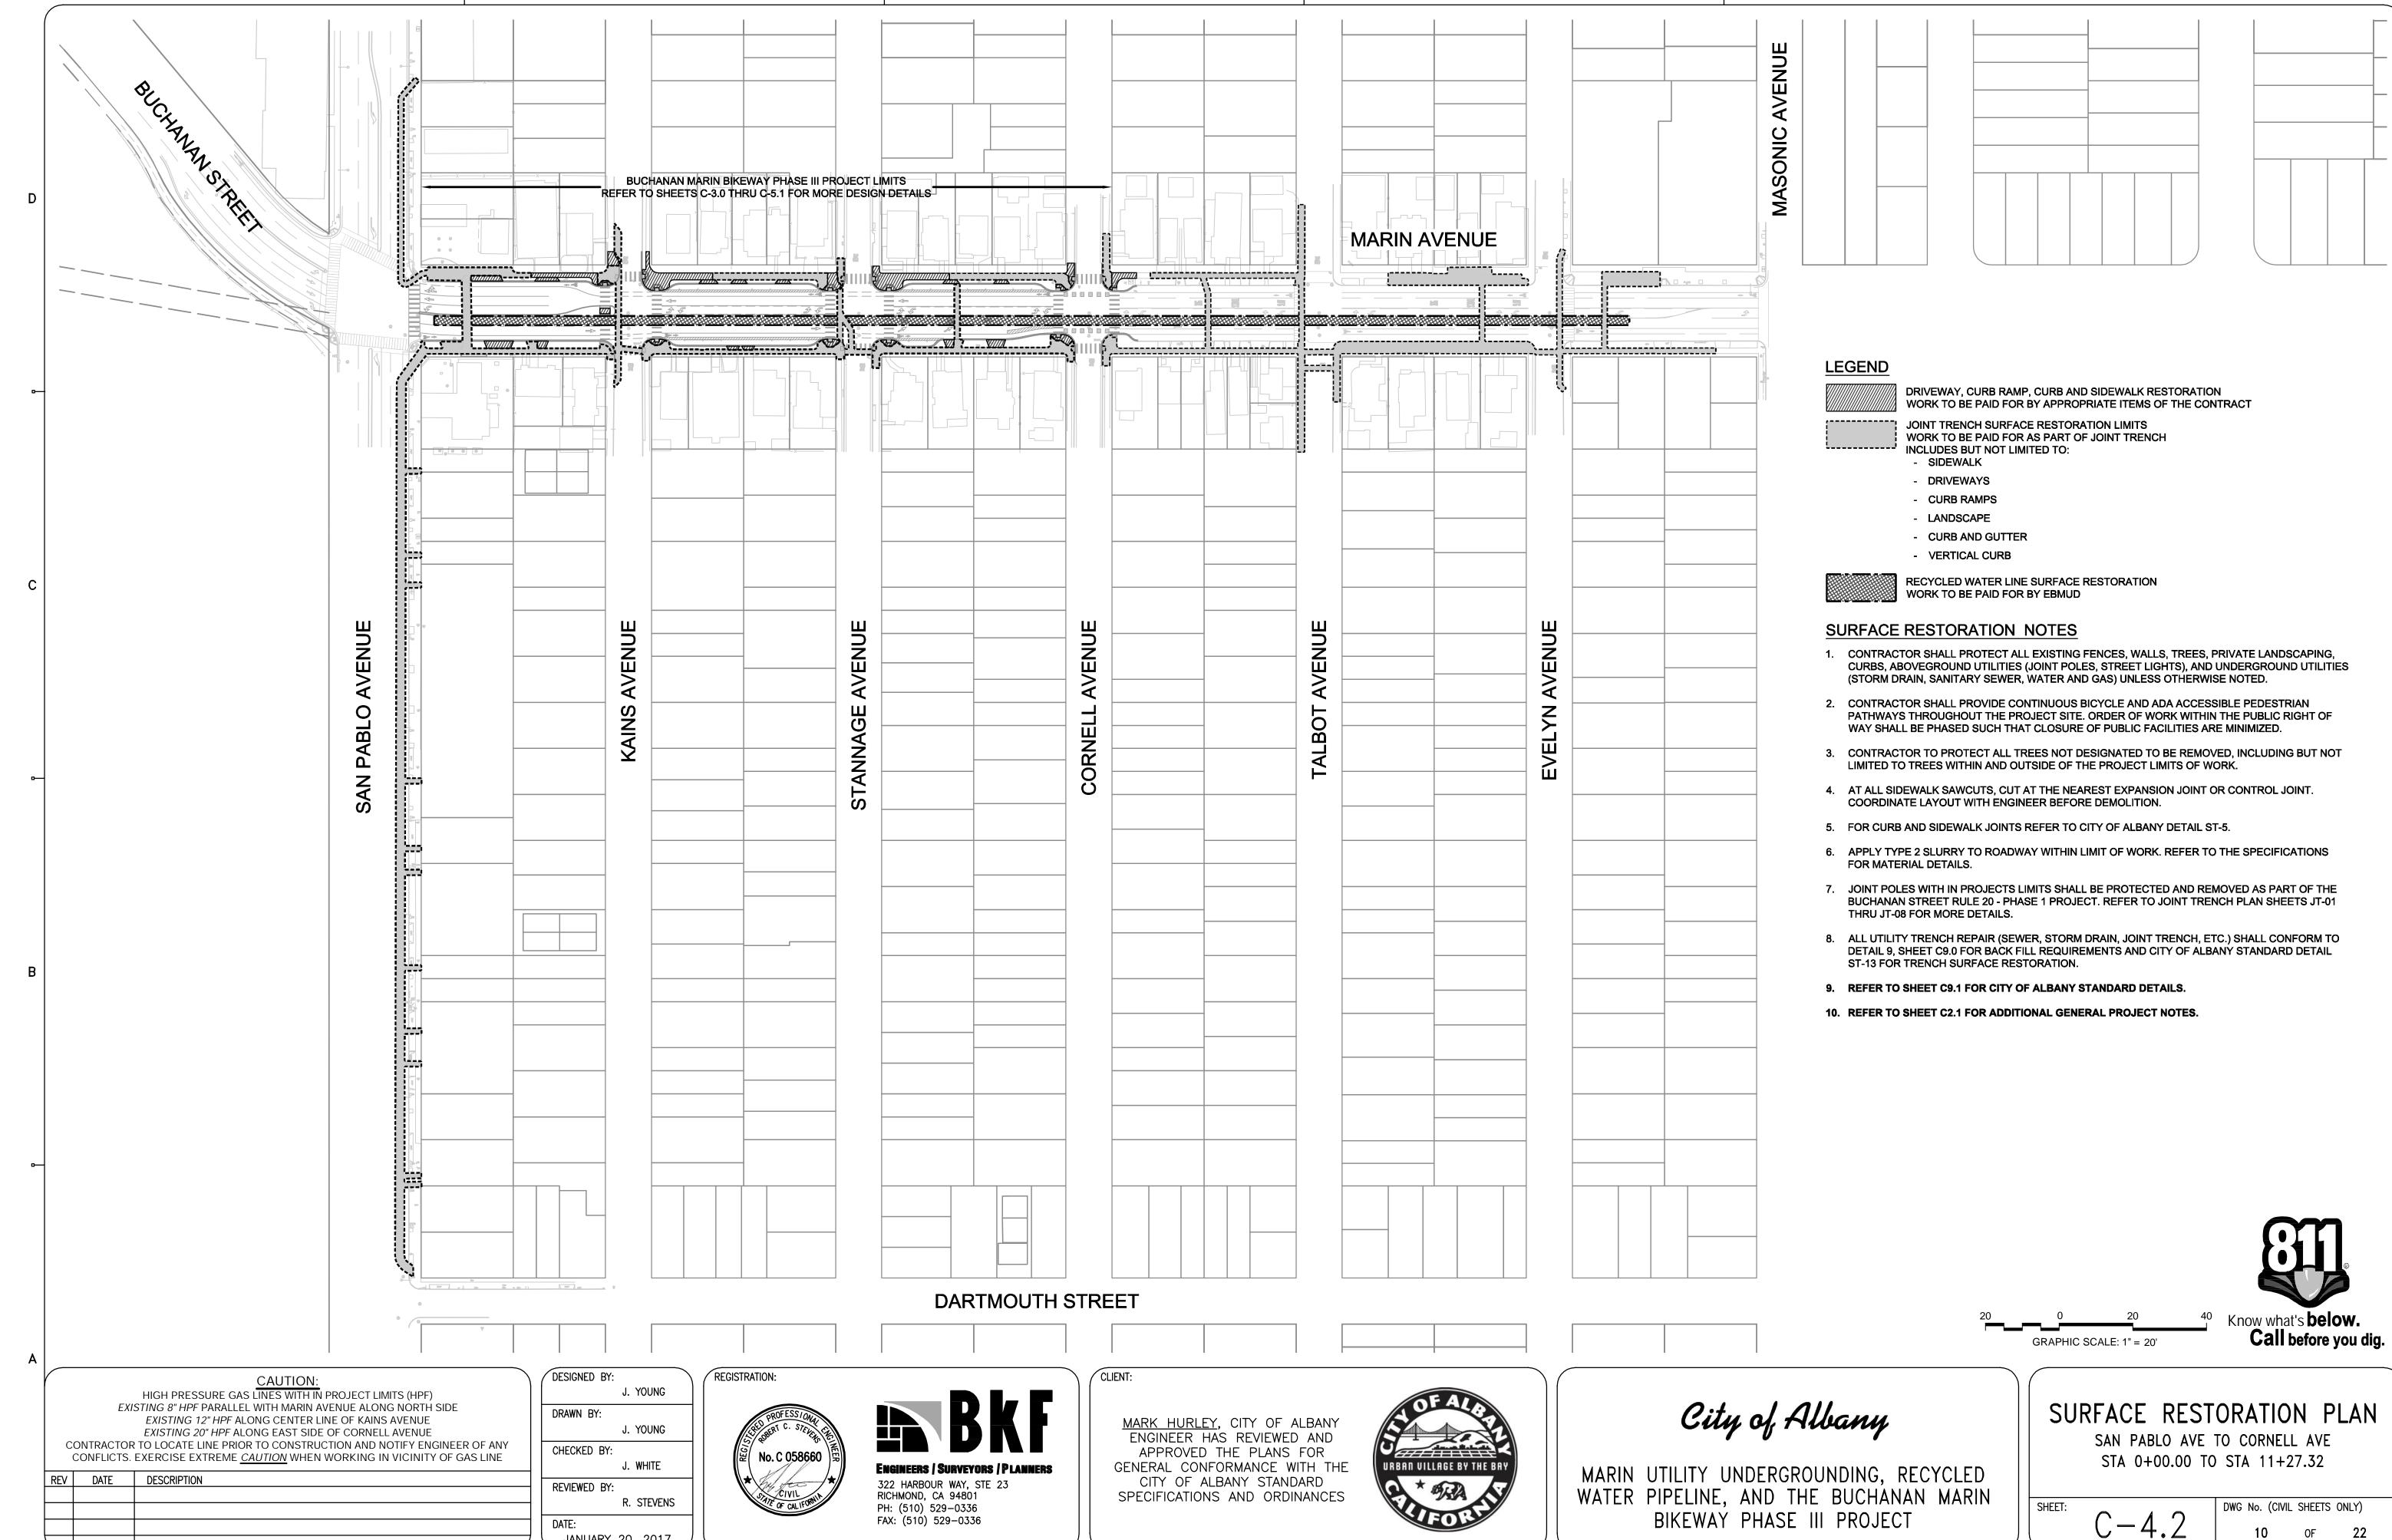
City of Albany

MARIN UTILITY UNDERGROUNDING, RECYCLED WATER PIPELINE, AND THE BUCHANAN MARIN BIKEWAY PHASE III PROJECT


HORIZONTAL LAYOUT

MARIN AVE (KAINS AVE TO CORNELL AVE) STA 5+14.86 TO STA 11+27.32

> DWG No. (CIVIL SHEETS ONLY) C-4.22 09 OF



JANUARY 20, 2017

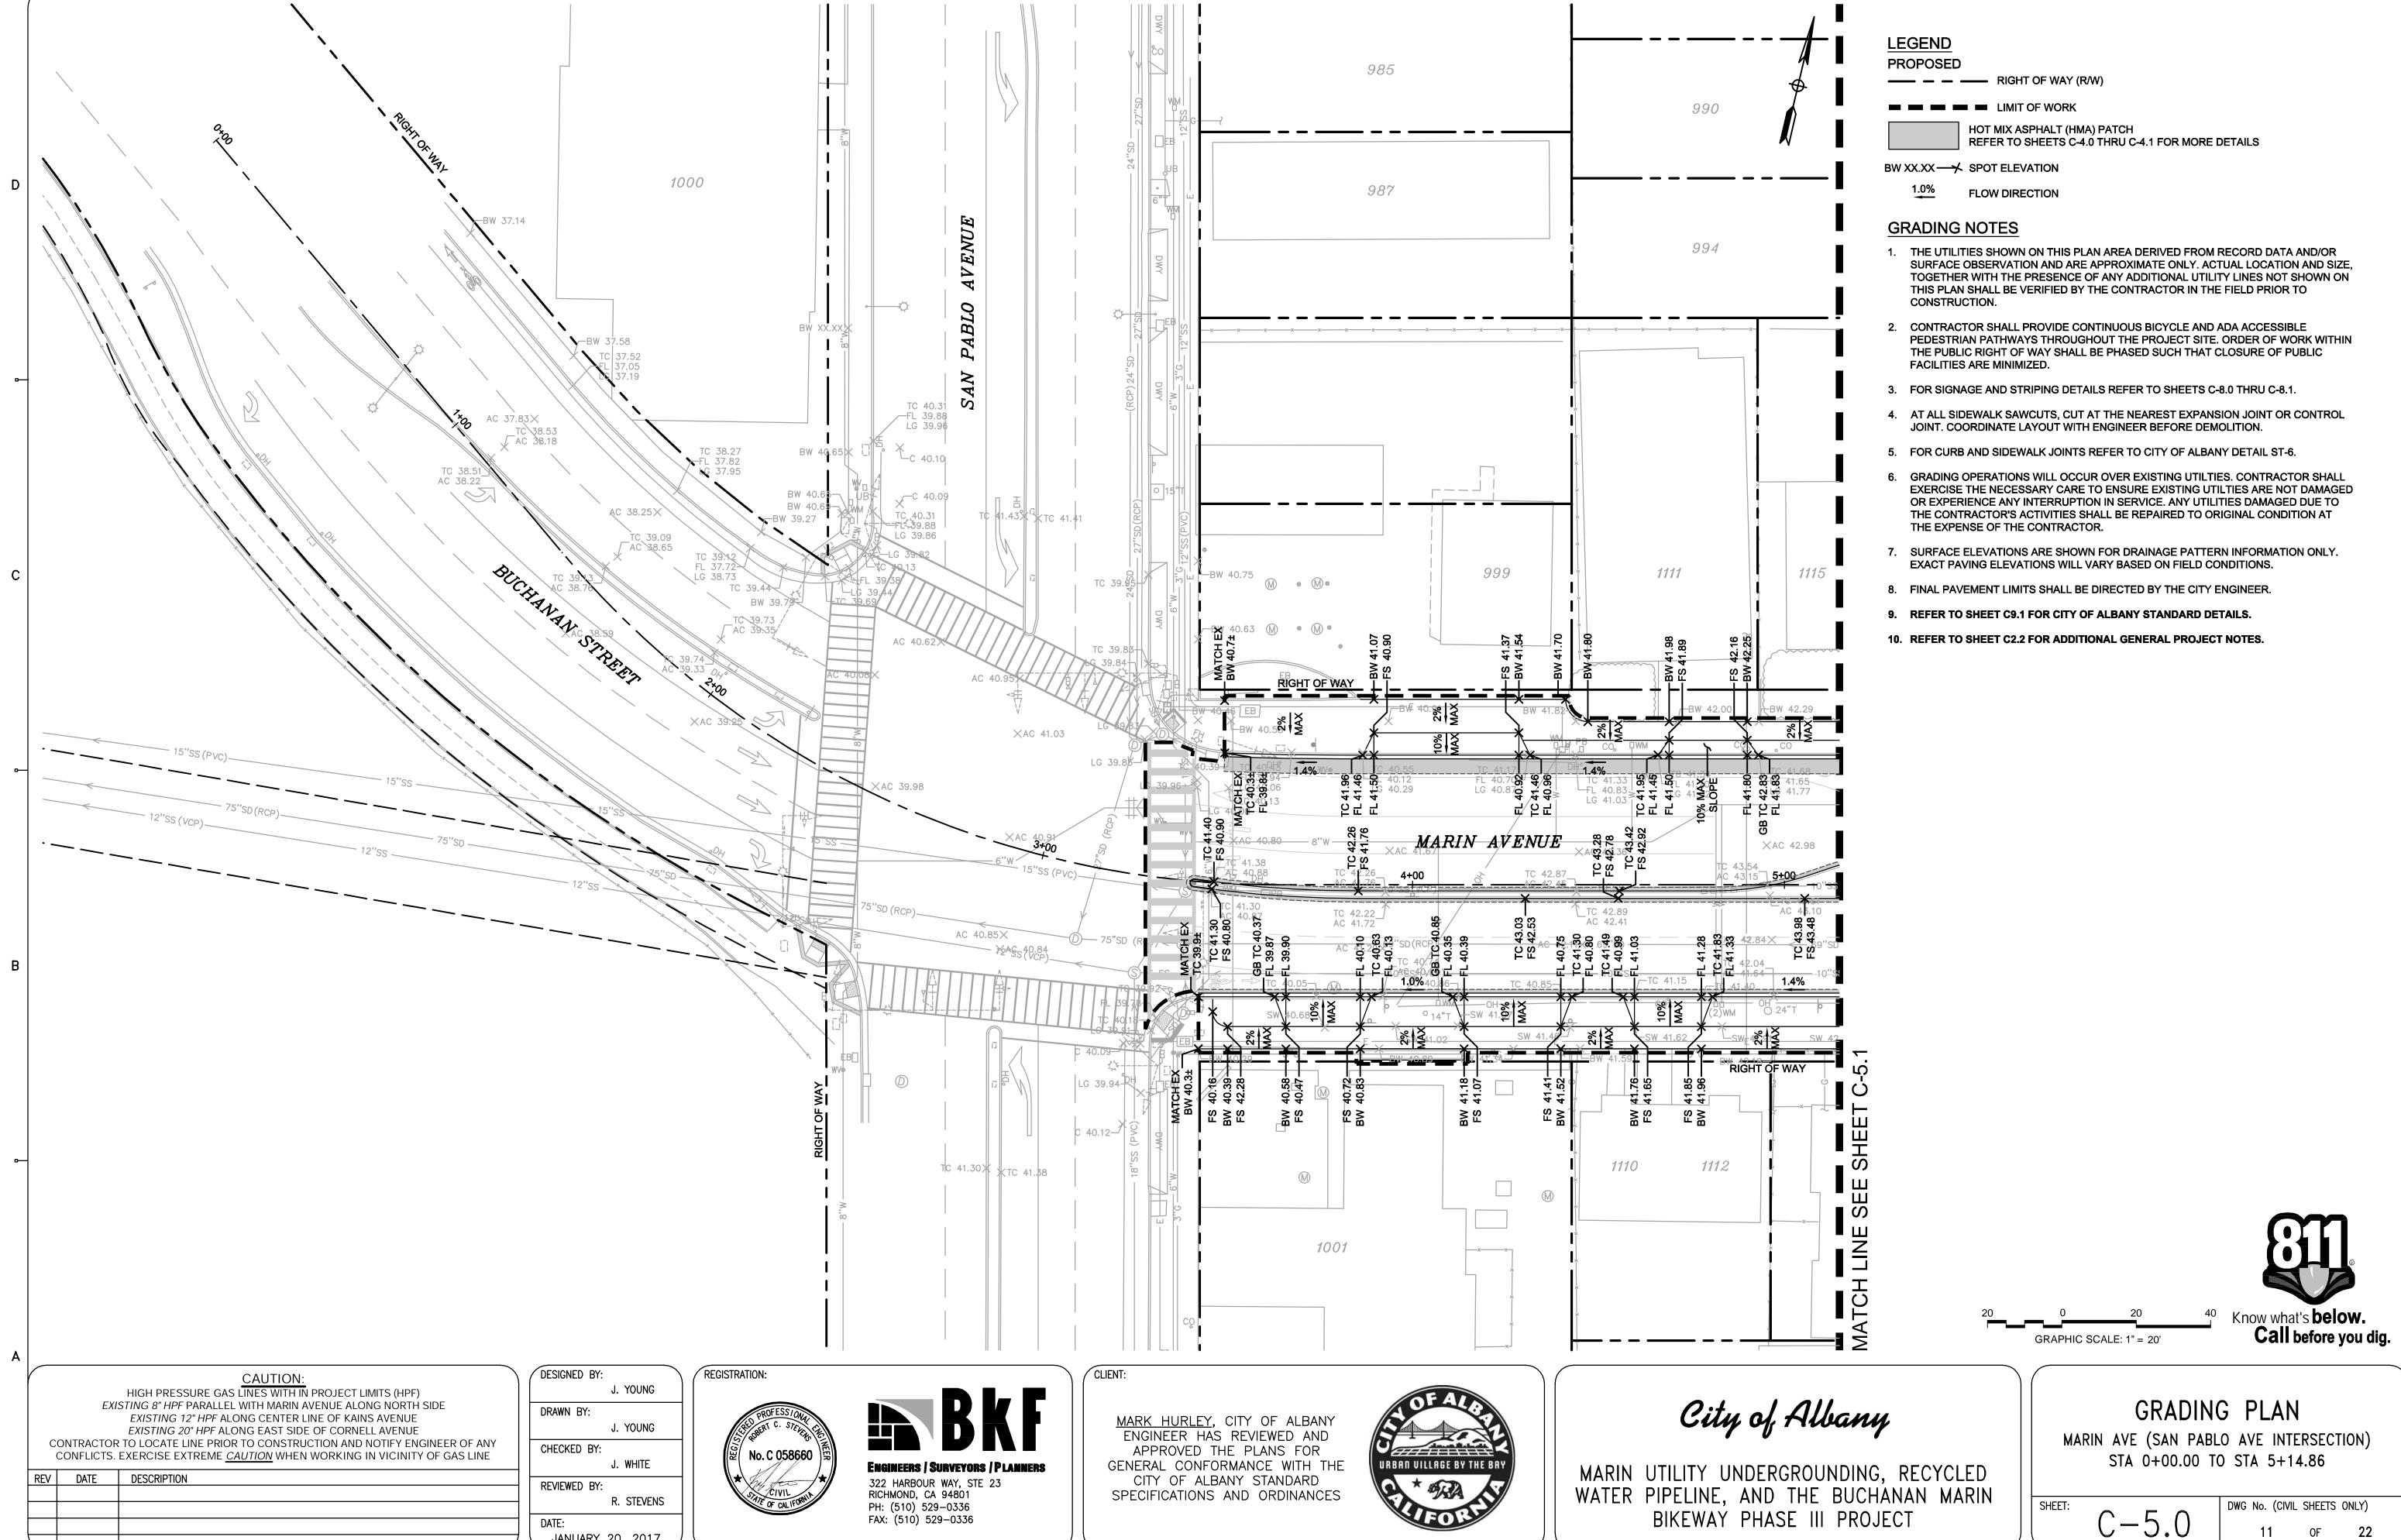


DATE:

JANUARY 20, 2017

CONSTRUCTION

22

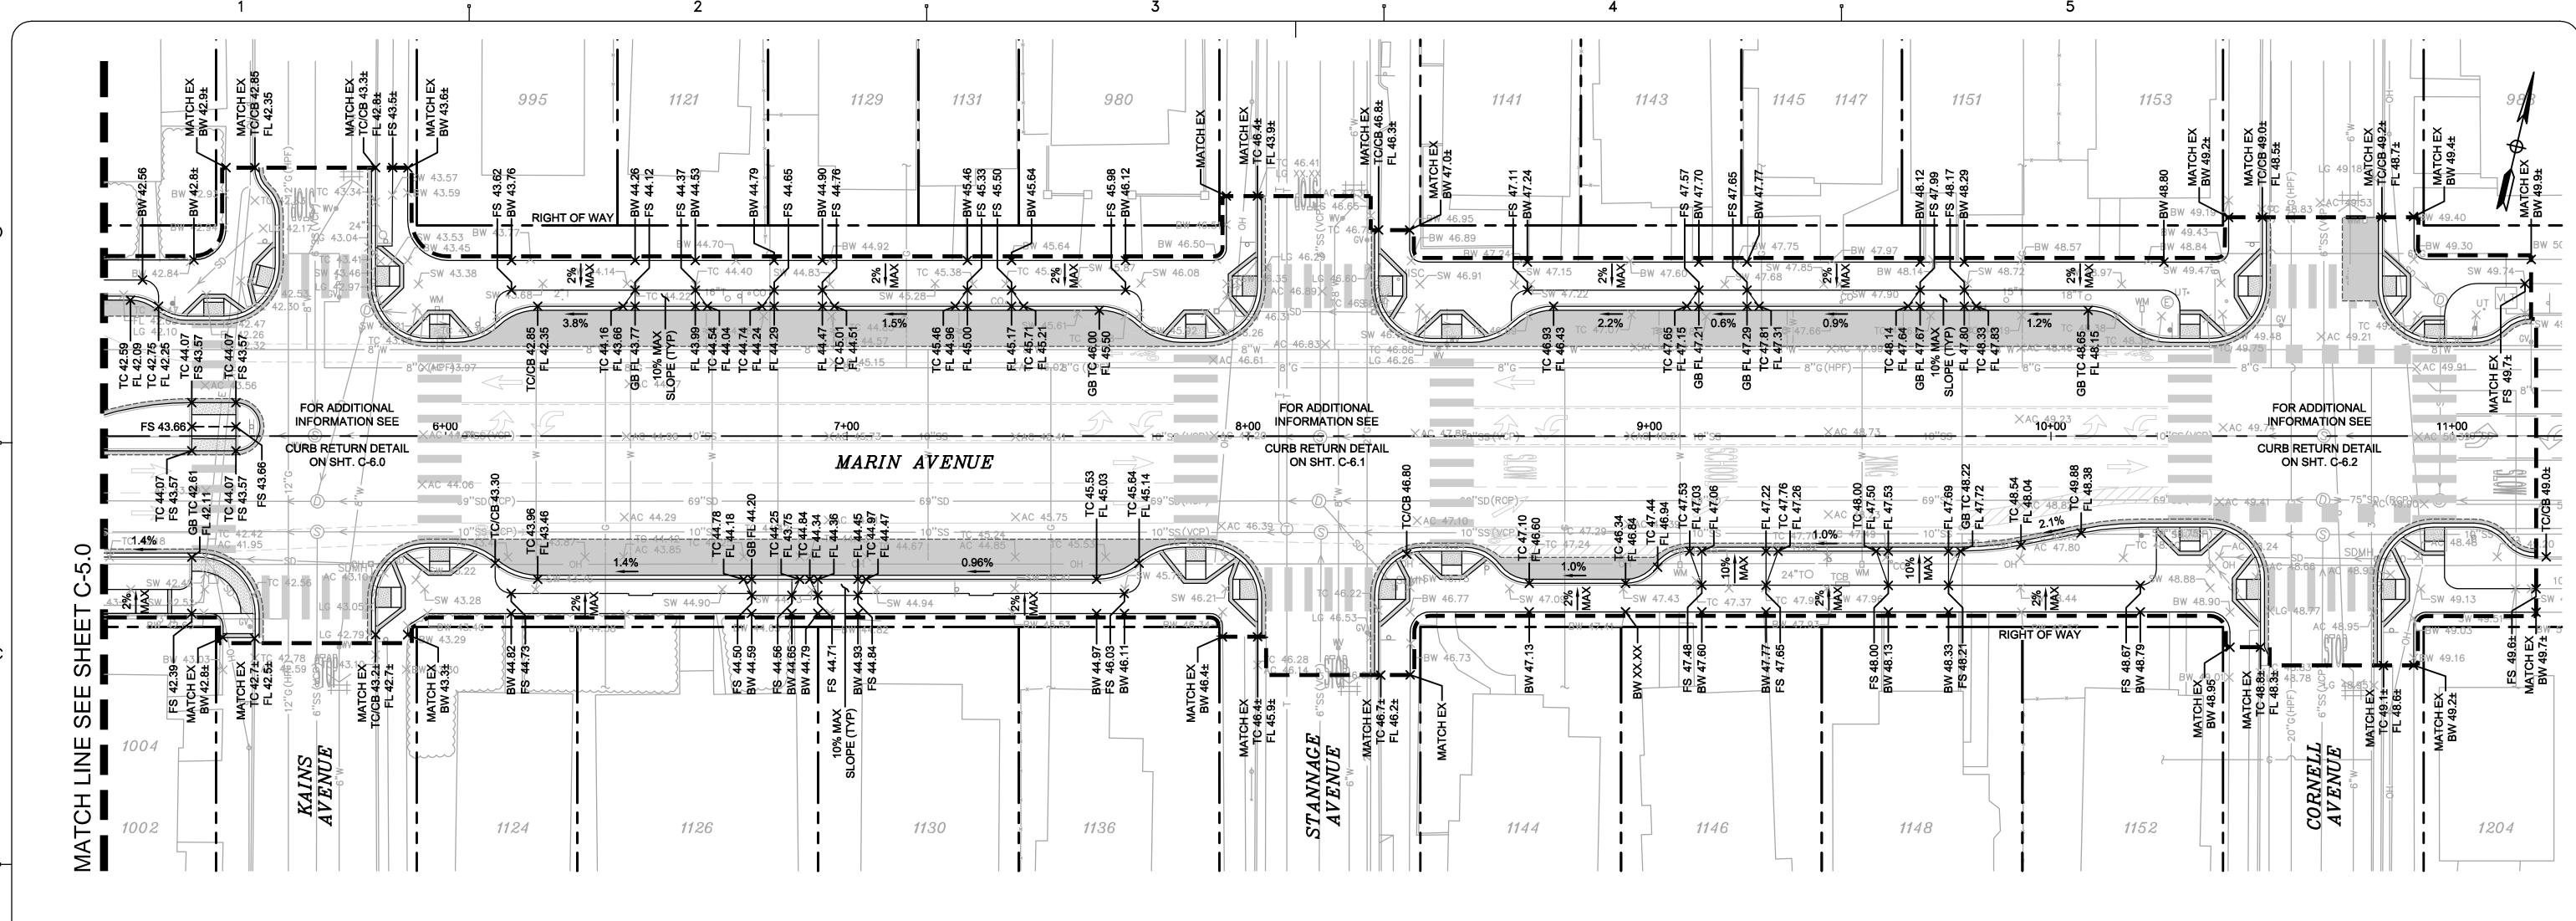11 OF



LEGEND

PROPOSED

LIMIT OF WORK

HOT MIX ASPHALT (HMA) PATCH REFER TO SHEETS C-4.0 THRU C-4.1 FOR MORE DETAILS

BW XX.XX → SPOT ELEVATION

1.0% FLOW DIRECTION **GRADING NOTES**

- THE UTILITIES SHOWN ON THIS PLAN AREA DERIVED FROM RECORD DATA AND/OR SURFACE OBSERVATION AND ARE APPROXIMATE ONLY. ACTUAL LOCATION AND SIZE, TOGETHER WITH THE PRESENCE OF ANY ADDITIONAL UTILITY LINES NOT SHOWN ON THIS PLAN SHALL BE VERIFIED BY THE CONTRACTOR IN THE FIELD PRIOR TO CONSTRUCTION.
- 2. CONTRACTOR SHALL PROVIDE CONTINUOUS BICYCLE AND ADA ACCESSIBLE PEDESTRIAN PATHWAYS THROUGHOUT THE PROJECT SITE. ORDER OF WORK WITHIN THE PUBLIC RIGHT OF WAY SHALL BE PHASED SUCH THAT CLOSURE OF PUBLIC FACILITIES ARE MINIMIZED.
- 3. FOR SIGNAGE AND STRIPING DETAILS REFER TO SHEETS C-8.0 THRU C-8.1.
- 4. AT ALL SIDEWALK SAWCUTS, CUT AT THE NEAREST EXPANSION JOINT OR CONTROL JOINT. COORDINATE LAYOUT WITH ENGINEER BEFORE DEMOLITION.
- 5. FOR CURB AND SIDEWALK JOINTS REFER TO CITY OF ALBANY DETAIL ST-6.
- 6. GRADING OPERATIONS WILL OCCUR OVER EXISTING UTILTIES. CONTRACTOR SHALL EXERCISE THE NECESSARY CARE TO ENSURE EXISTING UTILTIES ARE NOT DAMAGED OR EXPERIENCE ANY INTERRUPTION IN SERVICE. ANY UTILITIES DAMAGED DUE TO THE CONTRACTOR'S ACTIVITIES SHALL BE REPAIRED TO ORIGINAL CONDITION AT THE EXPENSE OF THE CONTRACTOR.
- 7. SURFACE ELEVATIONS ARE SHOWN FOR DRAINAGE PATTERN INFORMATION ONLY. EXACT PAVING **ELEVATIONS WILL VARY BASED ON FIELD CONDITIONS.**
- 8. FINAL PAVEMENT LIMITS SHALL BE DIRECTED BY THE CITY ENGINEER.
- 9. REFER TO SHEET C9.1 FOR CITY OF ALBANY STANDARD DETAILS.
- 10. REFER TO SHEET C2.2 FOR ADDITIONAL GENERAL PROJECT NOTES.

Know what's **below.** Call before you dig. GRAPHIC SCALE: 1" = 20'

CAUTION:

HIGH PRESSURE GAS LINES WITH IN PROJECT LIMITS (HPF) EXISTING 8" HPF PARALLEL WITH MARIN AVENUE ALONG NORTH SIDE EXISTING 12" HPF ALONG CENTER LINE OF KAINS AVENUE EXISTING 20" HPF ALONG EAST SIDE OF CORNELL AVENUE CONTRACTOR TO LOCATE LINE PRIOR TO CONSTRUCTION AND NOTIFY ENGINEER OF ANY

	CONFLICTS. EXERCISE EXTREME <u>CAUTION</u> WHEN WORKING IN VICINITY OF GAS LINE		
	REV	DATE	DESCRIPTION
Ī	1	01.31.17	ADDENDUM 1

DESIGNED BY: J. YOUNG

DRAWN BY: J. YOUNG CHECKED BY: J. WHITE REVIEWED BY: R. STEVENS

JANUARY 31, 2017

DATE:





MARK HURLEY, CITY OF ALBANY ENGINEER HAS REVIEWED AND APPROVED THE PLANS FOR GENERAL CONFORMANCE WITH THE

CITY OF ALBANY STANDARD

SPECIFICATIONS AND ORDINANCES



City of Albany

MARIN UTILITY UNDERGROUNDING, RECYCLED WATER PIPELINE, AND THE BUCHANAN MARIN BIKEWAY PHASE III PROJECT


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GRADING PLAN


MARIN AVE (KAINS AVE TO CORNELL AVE) STA 5+14.86 TO STA 11+27.32

STRUCTION

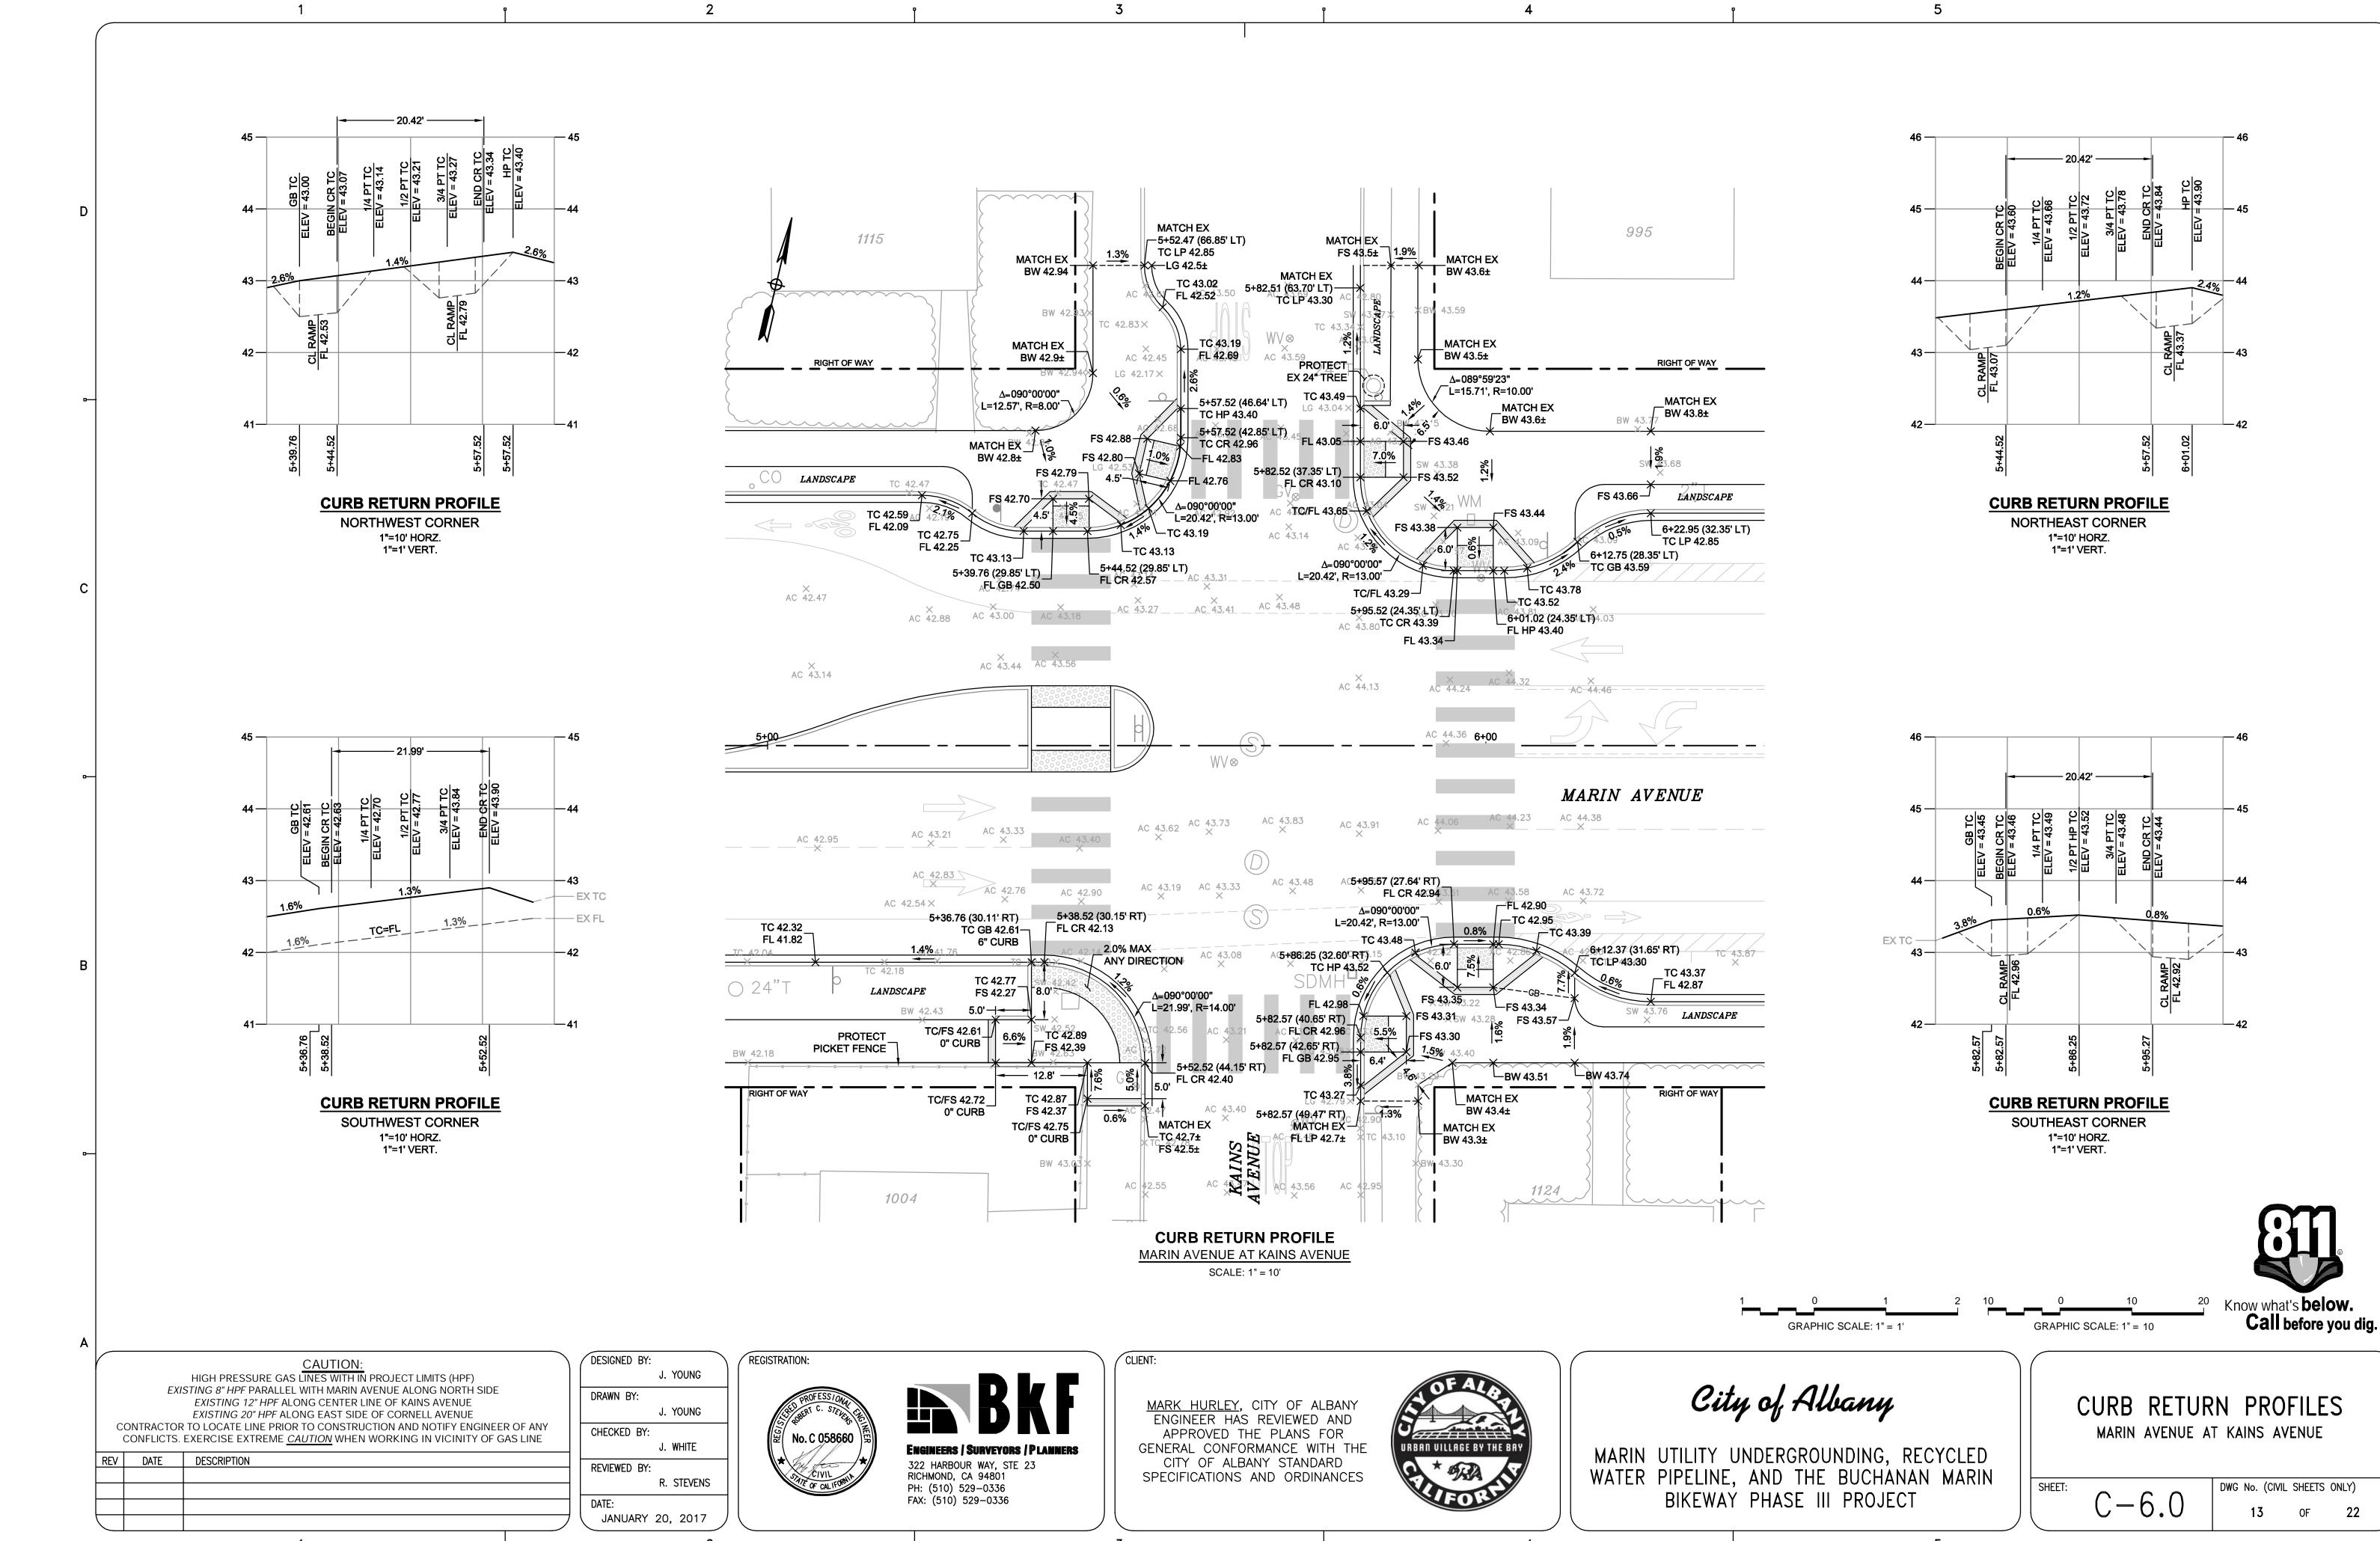
DWG No. (CIVIL SHEETS ONLY) C - 5.122 OF



CONSTRUCTION BID SUBMITTAL (01/20/20

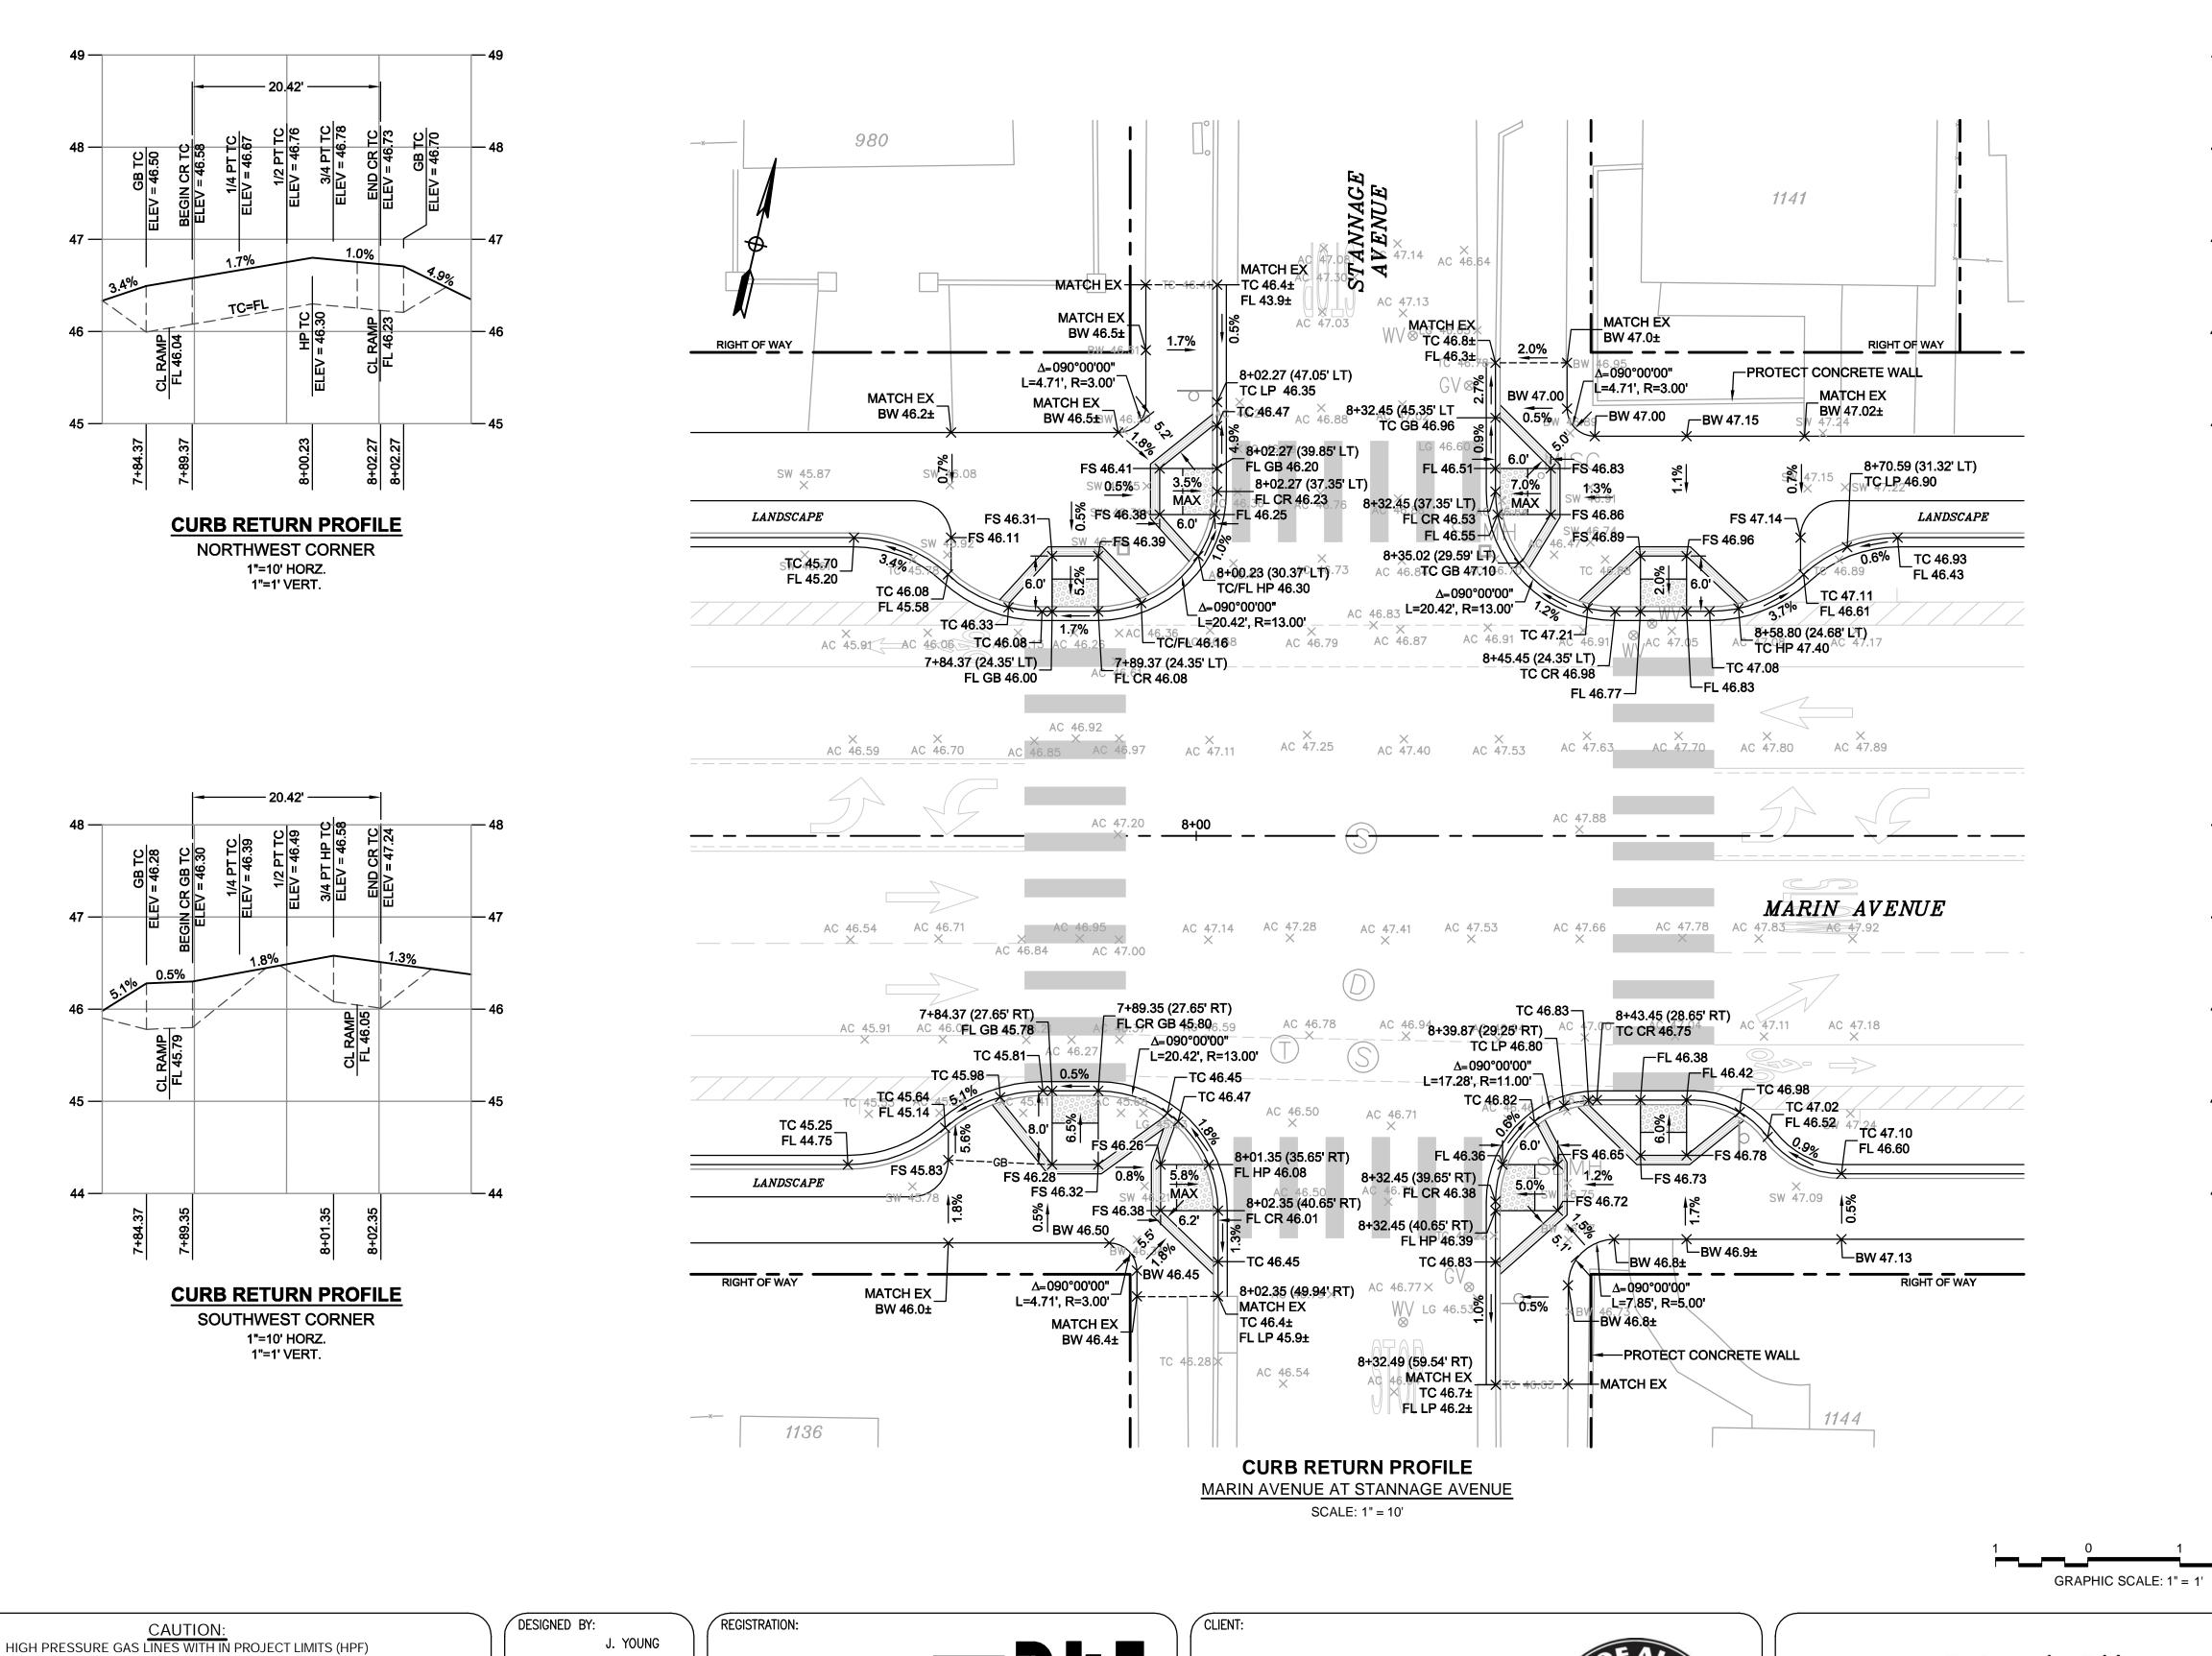

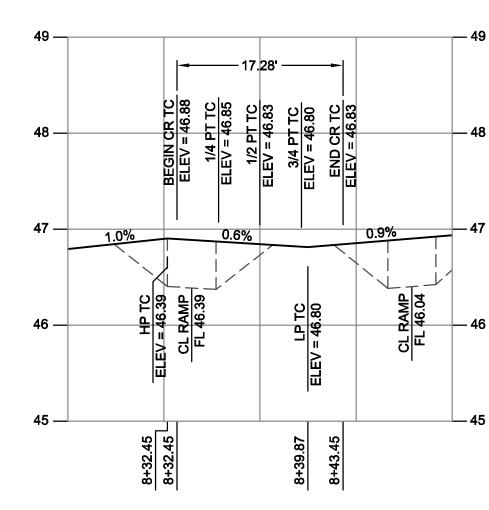CURB RETURN PROFILE NORTHEAST CORNER 1"=10' HORZ. 1"=1' VERT.



CURB RETURN PROFILE SOUTHEAST CORNER 1"=10' HORZ. 1"=1' VERT.

GRAPHIC SCALE: 1" = 10



CONSTRUCTION

EXISTING 8" HPF PARALLEL WITH MARIN AVENUE ALONG NORTH SIDE EXISTING 12" HPF ALONG CENTER LINE OF KAINS AVENUE EXISTING 20" HPF ALONG EAST SIDE OF CORNELL AVENUE CONTRACTOR TO LOCATE LINE PRIOR TO CONSTRUCTION AND NOTIFY ENGINEER OF ANY

CONFLICTS. EXERCISE EXTREME <u>CAUTION</u> WHEN WORKING IN VICINITY OF GAS LINE		
REV	DATE	DESCRIPTION

DRAWN BY: J. YOUNG CHECKED BY:

J. WHITE REVIEWED BY: R. STEVENS JANUARY 20, 2017



MARK HURLEY, CITY OF ALBANY ENGINEER HAS REVIEWED AND APPROVED THE PLANS FOR GENERAL CONFORMANCE WITH THE CITY OF ALBANY STANDARD SPECIFICATIONS AND ORDINANCES

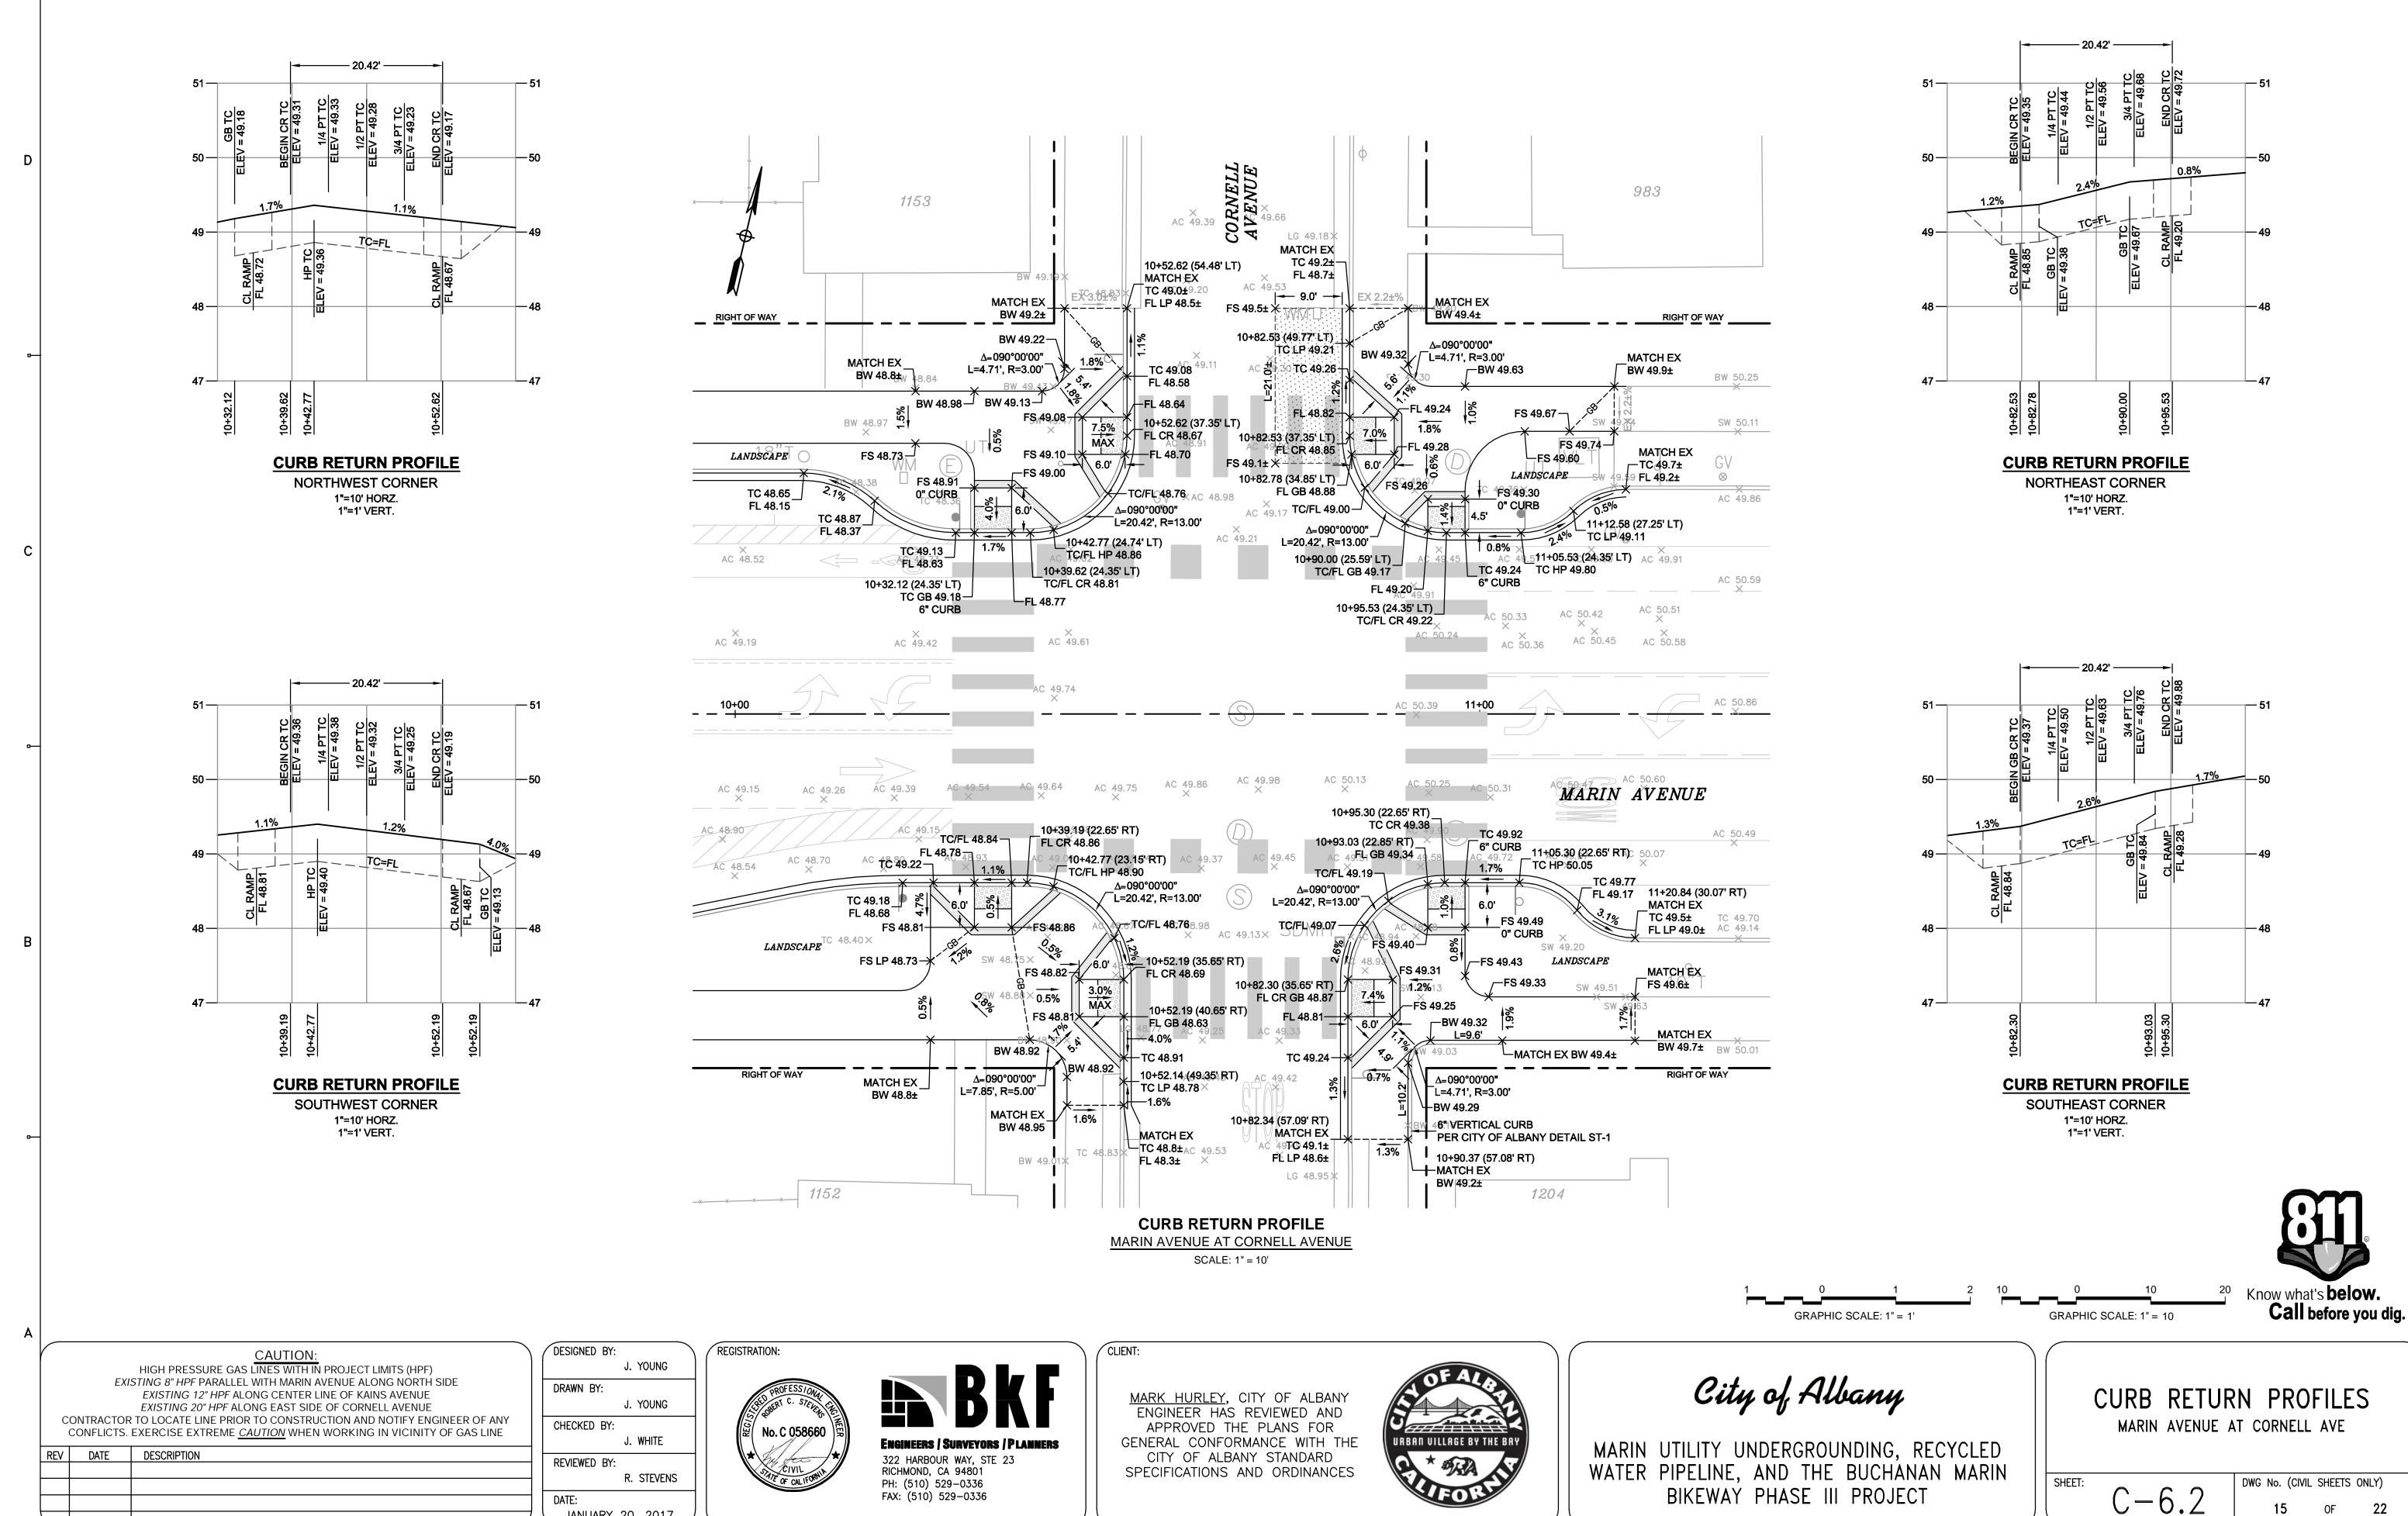


City of Albany

MARIN UTILITY UNDERGROUNDING, RECYCLED WATER PIPELINE, AND THE BUCHANAN MARIN BIKEWAY PHASE III PROJECT

CURB RETURN PROFILE MARIN AVENUE AT STANNAGE AVENUE

DWG No. (CIVIL SHEETS ONLY) C - 6.1**14** OF 22



FAX: (510) 529-0336

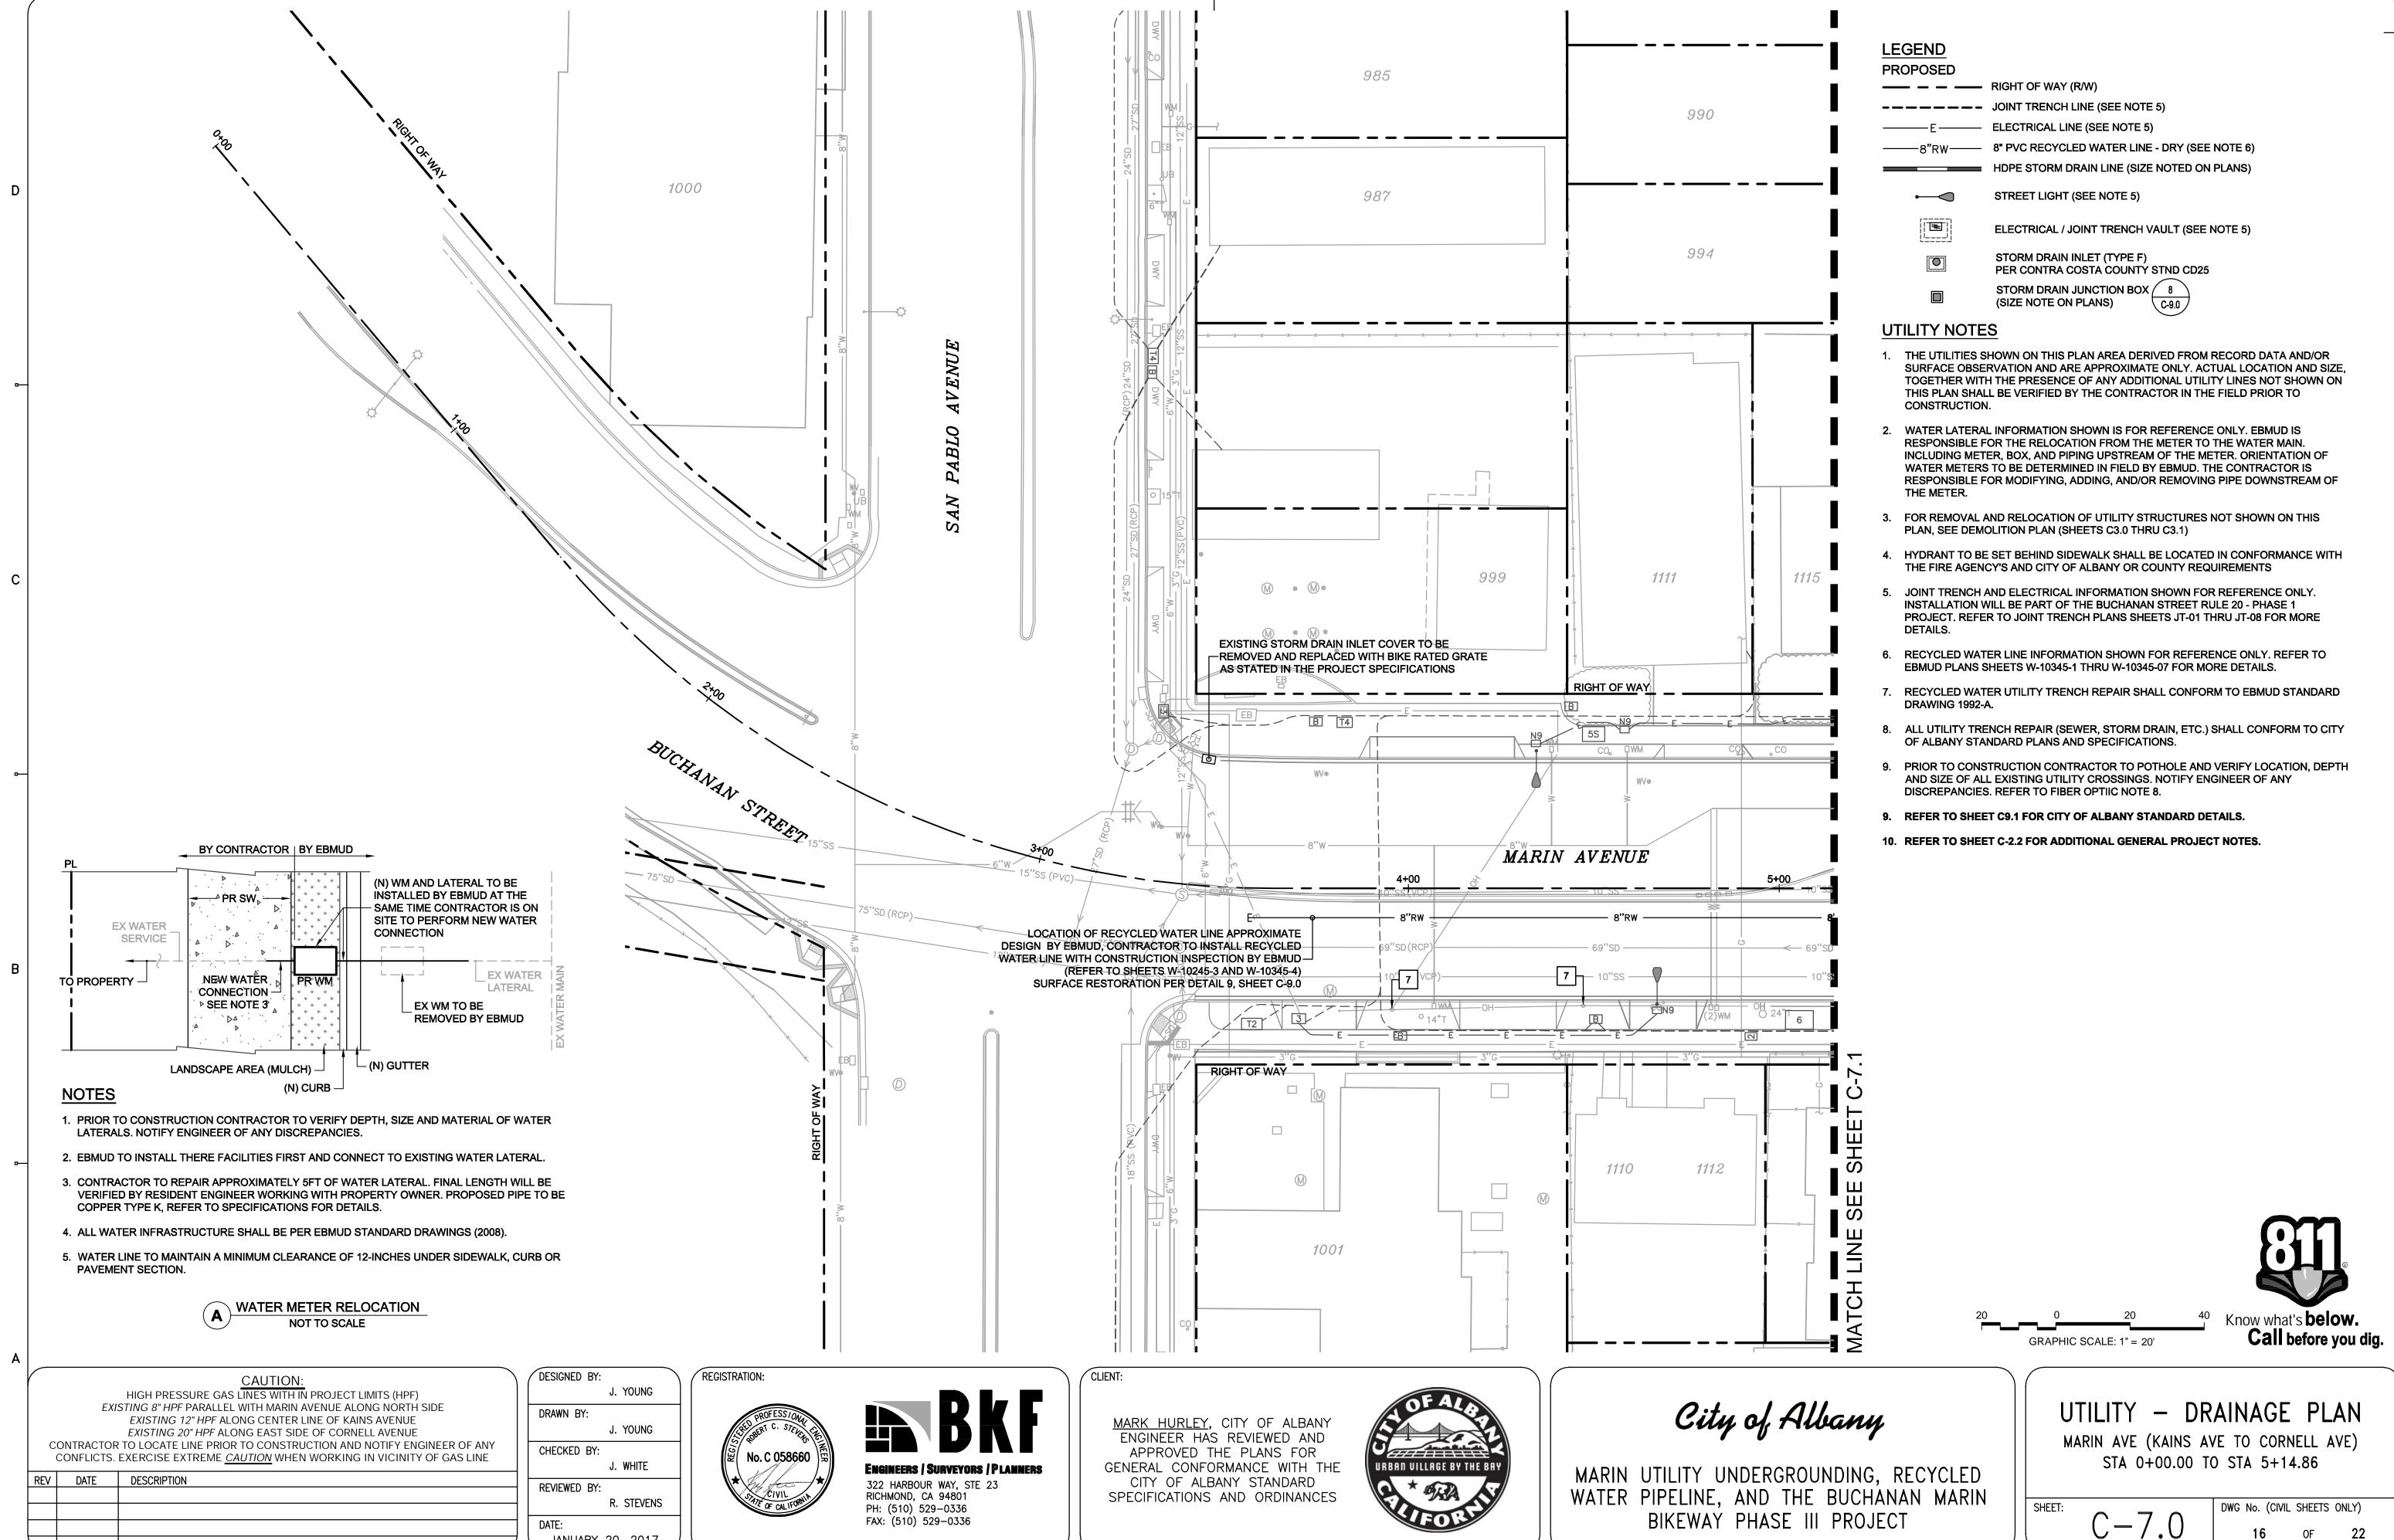
DATE:

JANUARY 20, 2017

CONSTRUCTION

15 OF

22




JANUARY 20, 2017

STRUCTION

22

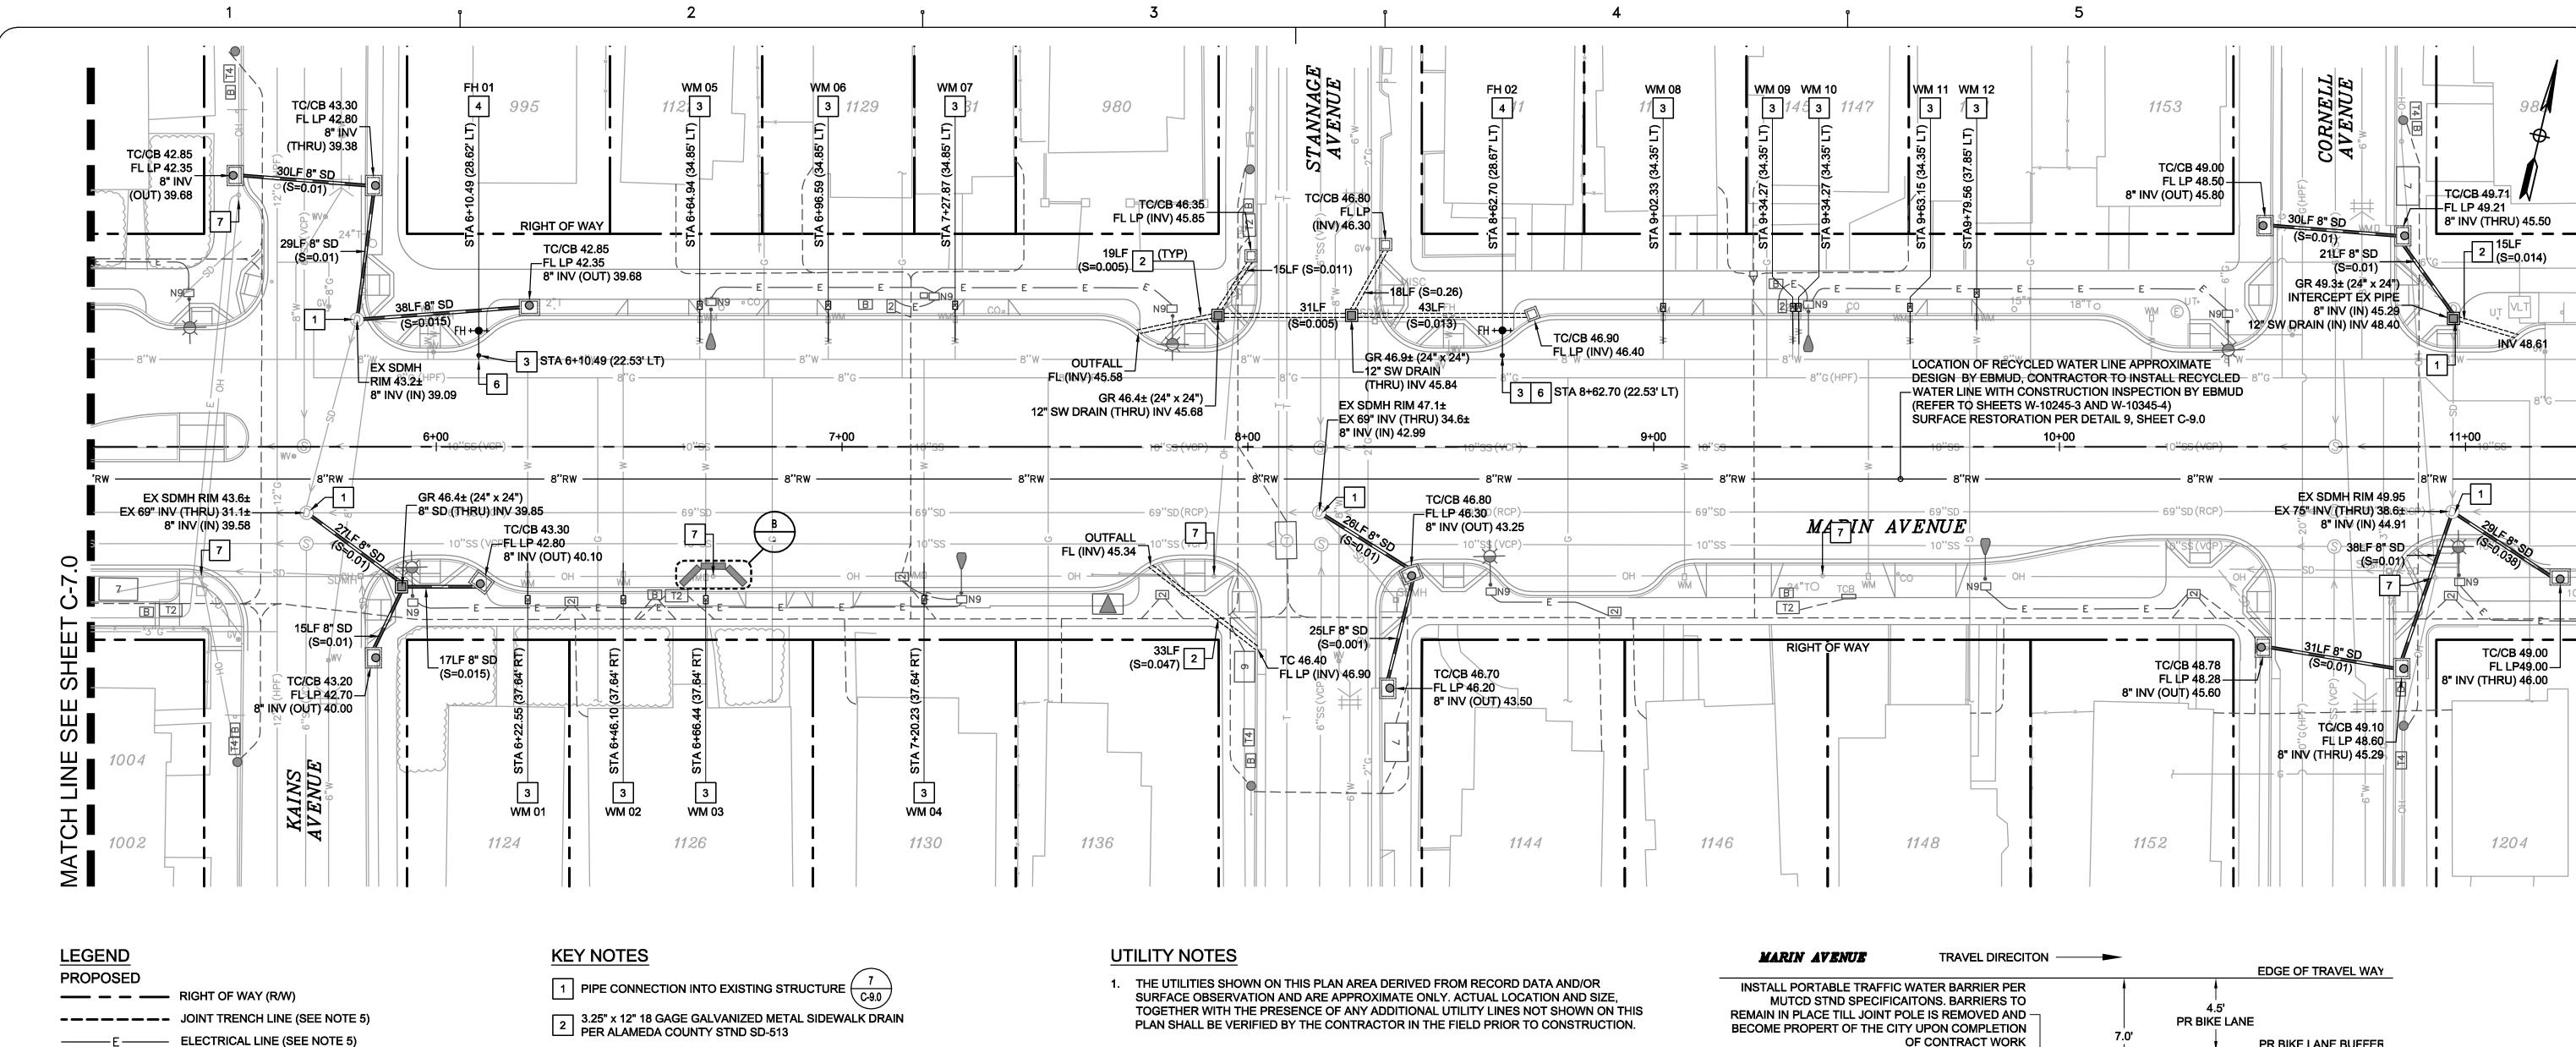OF



-----8"RW------ 8" PVC RECYCLED WATER LINE - DRY (SEE NOTE 6) HDPE STORM DRAIN LINE (SIZE NOTED ON PLANS)

STREET LIGHT (SEE NOTE 5)

ELECTRICAL / JOINT TRENCH VAULT (SEE NOTE 5)

STORM DRAIN INLET (TYPE F) 0 PER CONTRA COSTA COUNTY STND CD25

STORM DRAIN JUNCTION BOX / 8 (SIZE NOTE ON PLANS)

RELOCATE WATER METER BY EBMUD SEE DETAIL A, SHEET C-7.0

4 RELOCATED FIRE HYDRANT BY EBMUD


WATER VALVE
PER EBMUD STND DETAIL 288-EA

WATER LATERAL CONNECTION TO MAIN PER EBMUD STND DETAIL 238-EA

PROTECT EXISTING JOINT POLE 7 POLES TO BE REMOVED AS PART OF BUCHANAN STREET RULE 20 - PHASE 1 PROJECT


(* DUE TO UNKNOWN AGE AND CONDITION OF EXISTING PIPE, THE CONTRACTOR MAY NEED TO REPLACE MORE PIPE THAN SHOWN ON THE PLANS)						: PLANS)			
HOUSE NUMBER	WATER METER NUMBER	TOTAL NEW LATERAL LENGTH (FT)	CONTRACTOR RESPONSIBILITY	EBMUD RESPONSIBILITY	HOUSE NUMBER	WATER METER NUMBER	TOTAL NEW LATERAL LENGTH (FT)	CONTRACTOR RESPONSIBILITY	EBMUD RESPONSIBILITY
1124	WM 01	15.0'	5.0'	10.0'	1131	WM 07	15.0'	5.0'	10.0'
1126	WM 02	15.0'	5.0'	10.0'	1143	WM 08	15.0'	5.0'	10.0'
1126	WM 03	15.0'	5.0'	10.0'	1145	WM 09	15.0'	5.0'	10.0'
1130	WM 04	15.0'	5.0'	10.0'	1147	WM 10	15.0'	5.0'	10.0'
1121	WM 05	15.0'	5.0'	10.0'	1151	WM 11	15.0'	5.0'	10.0'
1129	WM 06	15.0'	5.0'	10.0'	1151	WM 12	15.0'	5.0'	10.0'

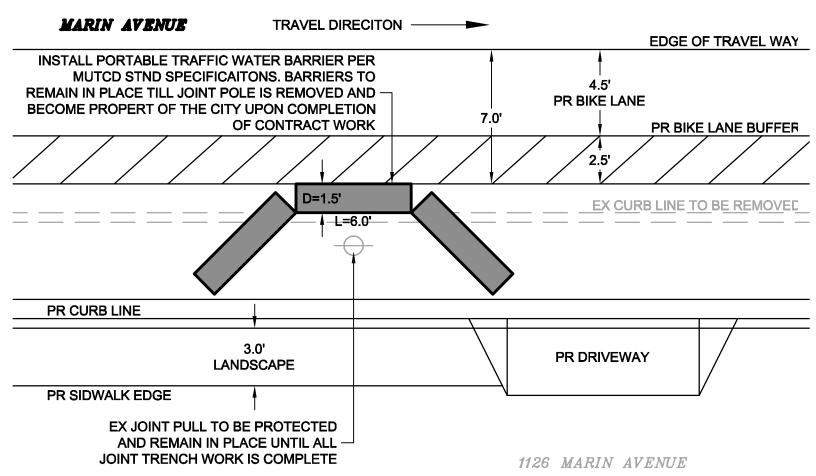- 2. WATER LATERAL INFORMATION SHOWN IS FOR REFERENCE ONLY. EBMUD IS RESPONSIBLE FOR THE RELOCATION FROM THE METER TO THE WATER MAIN. INCLUDING METER, BOX, AND PIPING UPSTREAM OF THE METER. ORIENTATION OF WATER METERS TO BE DETERMINED IN FIELD BY EBMUD. THE CONTRACTOR IS RESPONSIBLE FOR MODIFYING, ADDING, AND/OR REMOVING PIPE DOWNSTREAM OF THE METER.
- 3. FOR REMOVAL AND RELOCATION OF UTILITY STRUCTURES NOT SHOWN ON THIS PLAN, SEE DEMOLITION PLAN (SHEETS C3.0 THRU C3.1)
- 4. HYDRANT TO BE SET BEHIND SIDEWALK SHALL BE LOCATED IN CONFORMANCE WITH THE FIRE AGENCY'S AND CITY OF ALBANY OR COUNTY REQUIREMENTS
- 5. JOINT TRENCH AND ELECTRICAL INFORMATION SHOWN FOR REFERENCE ONLY. INSTALLATION WILL BE PART OF THE BUCHANAN STREET RULE 20 - PHASE 1 PROJECT. REFER TO JOINT TRENCH PLANS SHEETS JT-01 THRU JT-08 FOR MORE DETAILS.
- 6. RECYCLED WATER LINE INFORMATION SHOWN FOR REFERENCE ONLY. REFER TO EBMUD PLANS SHEETS W-10345-1 THRU W-10345-07 FOR MORE DETAILS.
- 7. RECYCLED WATER UTILITY TRENCH REPAIR SHALL CONFORM TO EBMUD STANDARD DRAWING 1992-A.
- 8. ALL UTILITY TRENCH REPAIR (SEWER, STORM DRAIN, ETC.) SHALL CONFORM TO CITY OF ALBANY STANDARD DETAIL ST-13 "TRENCH SURFACE RESTORATION DETAIL."
- 9. PRIOR TO CONSTRUCTION CONTRACTOR TO POTHOLE AND VERIFY LOCATION, DEPTH AND SIZE OF ALL EXISTING UTILITY CROSSINGS. NOTIFY ENGINEER OF ANY DISCREPANCIES.
- 9. REFER TO SHEET C9.1 FOR CITY OF ALBANY STANDARD DETAILS.
- 10. REFER TO SHEET C2.2 FOR ADDITIONAL GENERAL PROJECT NOTES.



JOINT POLE - TEMPROARY BARRIERS

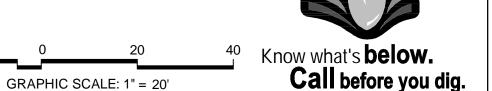5



CAUTION:

HIGH PRESSURE GAS LINES WITH IN PROJECT LIMITS (HPF) EXISTING 8" HPF PARALLEL WITH MARIN AVENUE ALONG NORTH SIDE EXISTING 12" HPF ALONG CENTER LINE OF KAINS AVENUE EXISTING 20" HPF ALONG EAST SIDE OF CORNELL AVENUE CONTRACTOR TO LOCATE LINE PRIOR TO CONSTRUCTION AND NOTIFY ENGINEER OF ANY

	CONFLICTS. EXERCISE EXTREME <u>CAUTION</u> WHEN WORKING IN VICINITY OF GAS LINE		
	REV	DATE	DESCRIPTION
	1	01.31.17	ADDENDUM 1

DESIGNED BY: J. YOUNG DRAWN BY:

J. YOUNG CHECKED BY: J. WHITE REVIEWED BY: R. STEVENS

JANUARY 31, 2017

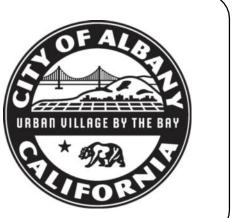
DATE:





FAX: (510) 529-0336

MARK HURLEY, CITY OF ALBANY ENGINEER HAS REVIEWED AND APPROVED THE PLANS FOR GENERAL CONFORMANCE WITH THE CITY OF ALBANY STANDARD SPECIFICATIONS AND ORDINANCES



City of Albany

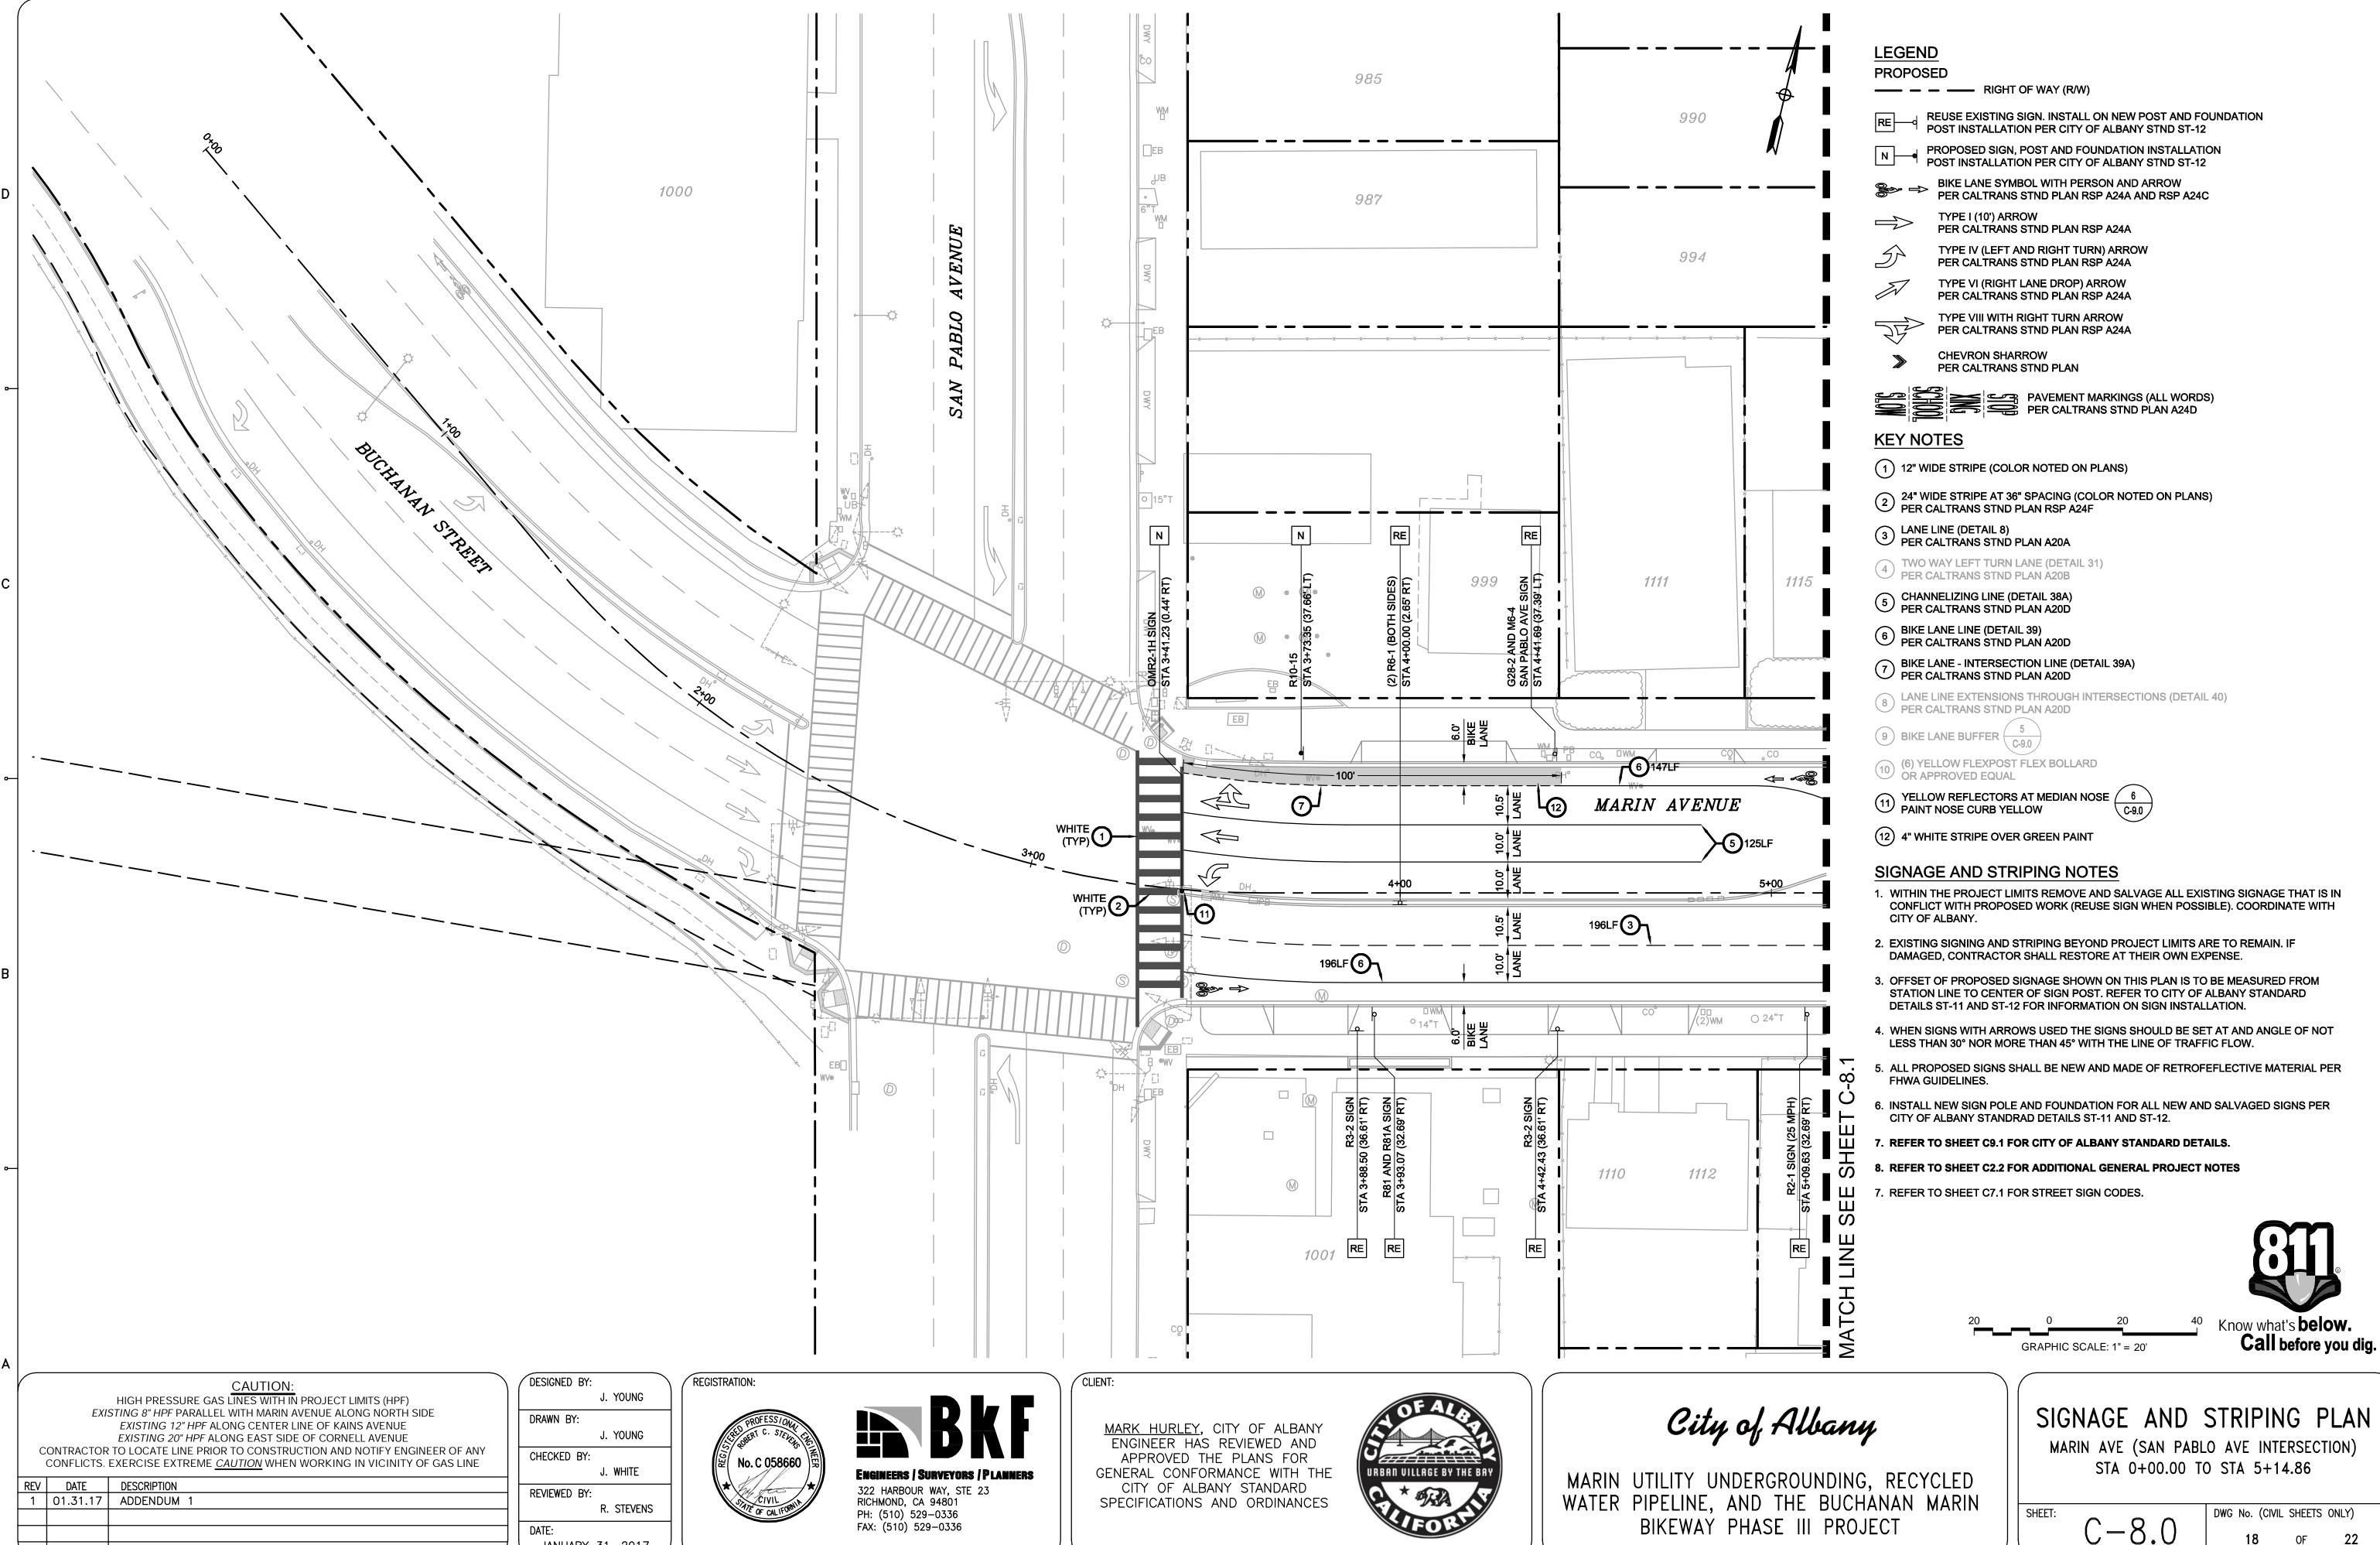
MARIN UTILITY UNDERGROUNDING, RECYCLED WATER PIPELINE, AND THE BUCHANAN MARIN BIKEWAY PHASE III PROJECT

UTILITY - DRAINAGE PLAN MARIN AVE (KAINS AVE TO CORNELL AVE) STA 5+14.86 TO STA 11+27.32

DWG No. (CIVIL SHEETS ONLY) C - 7.1OF 22

SHEET:


STRUCTION



JANUARY 31, 2017

C - 8.0

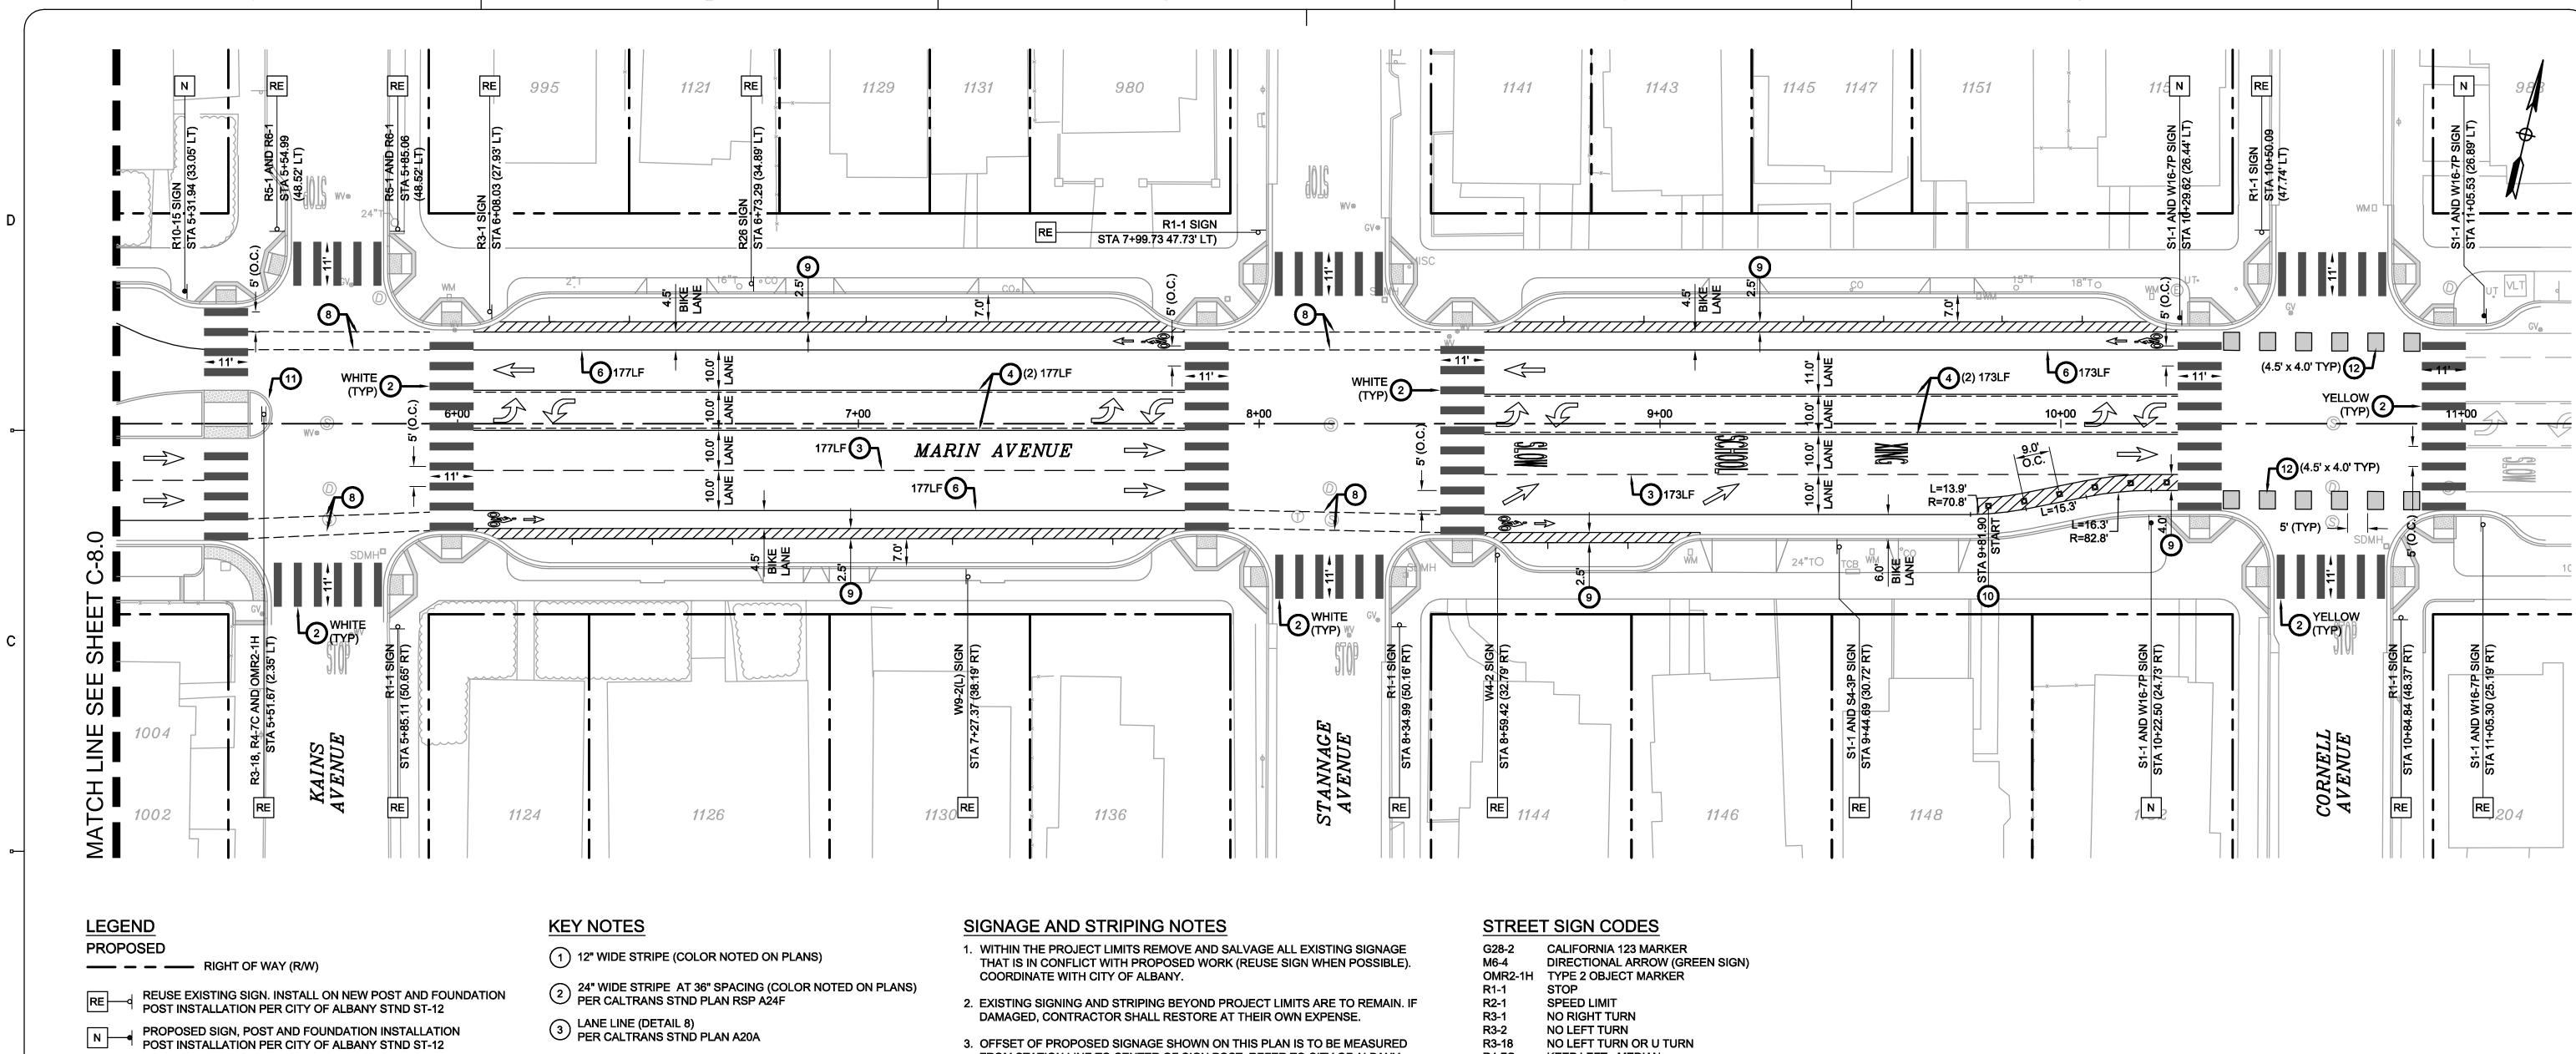OF



KEYNOTE NO USED ON SHEET

BIKE LANE SYMBOL WITH PERSON AND ARROW PER CALTRANS STND PLAN RSP A24A AND RSP A24C

TYPE I (10') ARROW PER CALTRANS STND PLAN RSP A24A

TYPE IV (LEFT AND RIGHT TURN) ARROW PER CALTRANS STND PLAN RSP A24A

PER CALTRANS STND PLAN RSP A24A TYPE VIII WITH RIGHT TURN ARROW

TYPE VI (RIGHT LANE DROP) ARROW

PER CALTRANS STND PLAN RSP A24A

CHEVRON SHARROW PER CALTRANS STND PLAN



- TWO WAY LEFT TURN LANE (DETAIL 31)
 PER CALTRANS STND PLAN A20B
- 5 CHANNELIZING LINE (DETAIL 38A) PER CALTRANS STND PLAN A20D
- 6 BIKE LANE LINE (DETAIL 39) PER CALTRANS STND PLAN A20D
- 7 BIKE LANE INTERSECTION LINE (DETAIL 39A) PER CALTRANS STND PLAN A20D
- 8 LANE LINE EXTENSIONS THROUGH INTERSECTIONS (DETAIL 40) PER CALTRANS STND PLAN A20D
- 9 BIKE LANE BUFFER $\frac{5}{\text{C-9.0}}$ (6) YELLOW FLEXPOST FLEX BOLLARD OR APPROVED EQUAL
- YELLOW REFLECTORS AT MEDIAN NOSE 6
 PAINT NOSE CURB YELLOW

 6
 C-9.0
- (12) 4" WHITE STRIPE OVER GREEN PAINT

- FROM STATION LINE TO CENTER OF SIGN POST. REFER TO CITY OF ALBANY STANDARD DETAILS ST-11 AND ST-12 FOR INFORMATION ON SIGN INSTALLATION.
- 4. WHEN SIGNS WITH ARROWS USED THE SIGNS SHOULD BE SET AT AND ANGLE OF NOT LESS THAN 30° NOR MORE THAN 45° WITH THE LINE OF TRAFFIC FLOW.
- 5. ALL PROPOSED SIGNS SHALL BE NEW AND MADE OF RETROFEFLECTIVE MATERIAL PER FHWA GUIDELINES.
- 6. INSTALL NEW SIGN POLE AND FOUNDATION FOR ALL NEW AND SALVAGED SIGNS PER CITY OF ALBANY STANDRAD DETAILS ST-11 AND ST-12.
- 7. REFER TO SHEET C9.1 FOR CITY OF ALBANY STANDARD DETAILS.
- 8. REFER TO SHEET C2.2 FOR ADDITIONAL GENERAL PROJECT NOTES

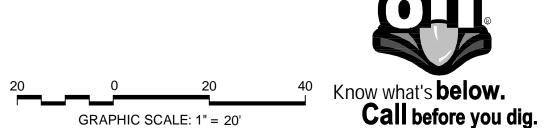
R4-7C **KEEP LEFT - MEDIAN** R5-1 DO NOT ENTER

ONE WAY R10-15 TURNING VEHICULES YIELD TO BIKE (MODIFIED SIGN) NO PARKING ANY TIME R26 BIKE PATH, NO MOTOR VEHICLES OR MORIZED BIKES R44A

R81 **BIKE LANE R81A** "BEGIN" R81B "END"

ACCESSIBLE PARKING ONLY R99 S1-1 **SCHOOL CROSSING**

S4-3P "SCHOOL" SCHOOL CROSSING WITH ARROW SW24-2 W4-2 LAND ENDS SYMBOL LANE ENDS MERGE LEFT



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	CONFLICTS. EXERCISE EXTREME <u>CAUTION</u> WHEN WORKING IN VICINITY OF GAS LIN				
	REV	DATE	DESCRIPTION		
	1	01.31.17	ADDENDUM 1		

DESIGNED BY: J. YOUNG

DRAWN BY: J. YOUNG CHECKED BY: J. WHITE REVIEWED BY:

JANUARY 31, 2017

DATE:

R. STEVENS



REGISTRATION:

ENGINEERS / SURVEYORS / PLANNERS 322 HARBOUR WAY, STE 23 RICHMOND, CA 94801 PH: (510) 529-0336 FAX: (510) 529-0336

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City of Albany

MARIN UTILITY UNDERGROUNDING, RECYCLED WATER PIPELINE, AND THE BUCHANAN MARIN BIKEWAY PHASE III PROJECT

SIGNAGE AND STRIPING PLAN

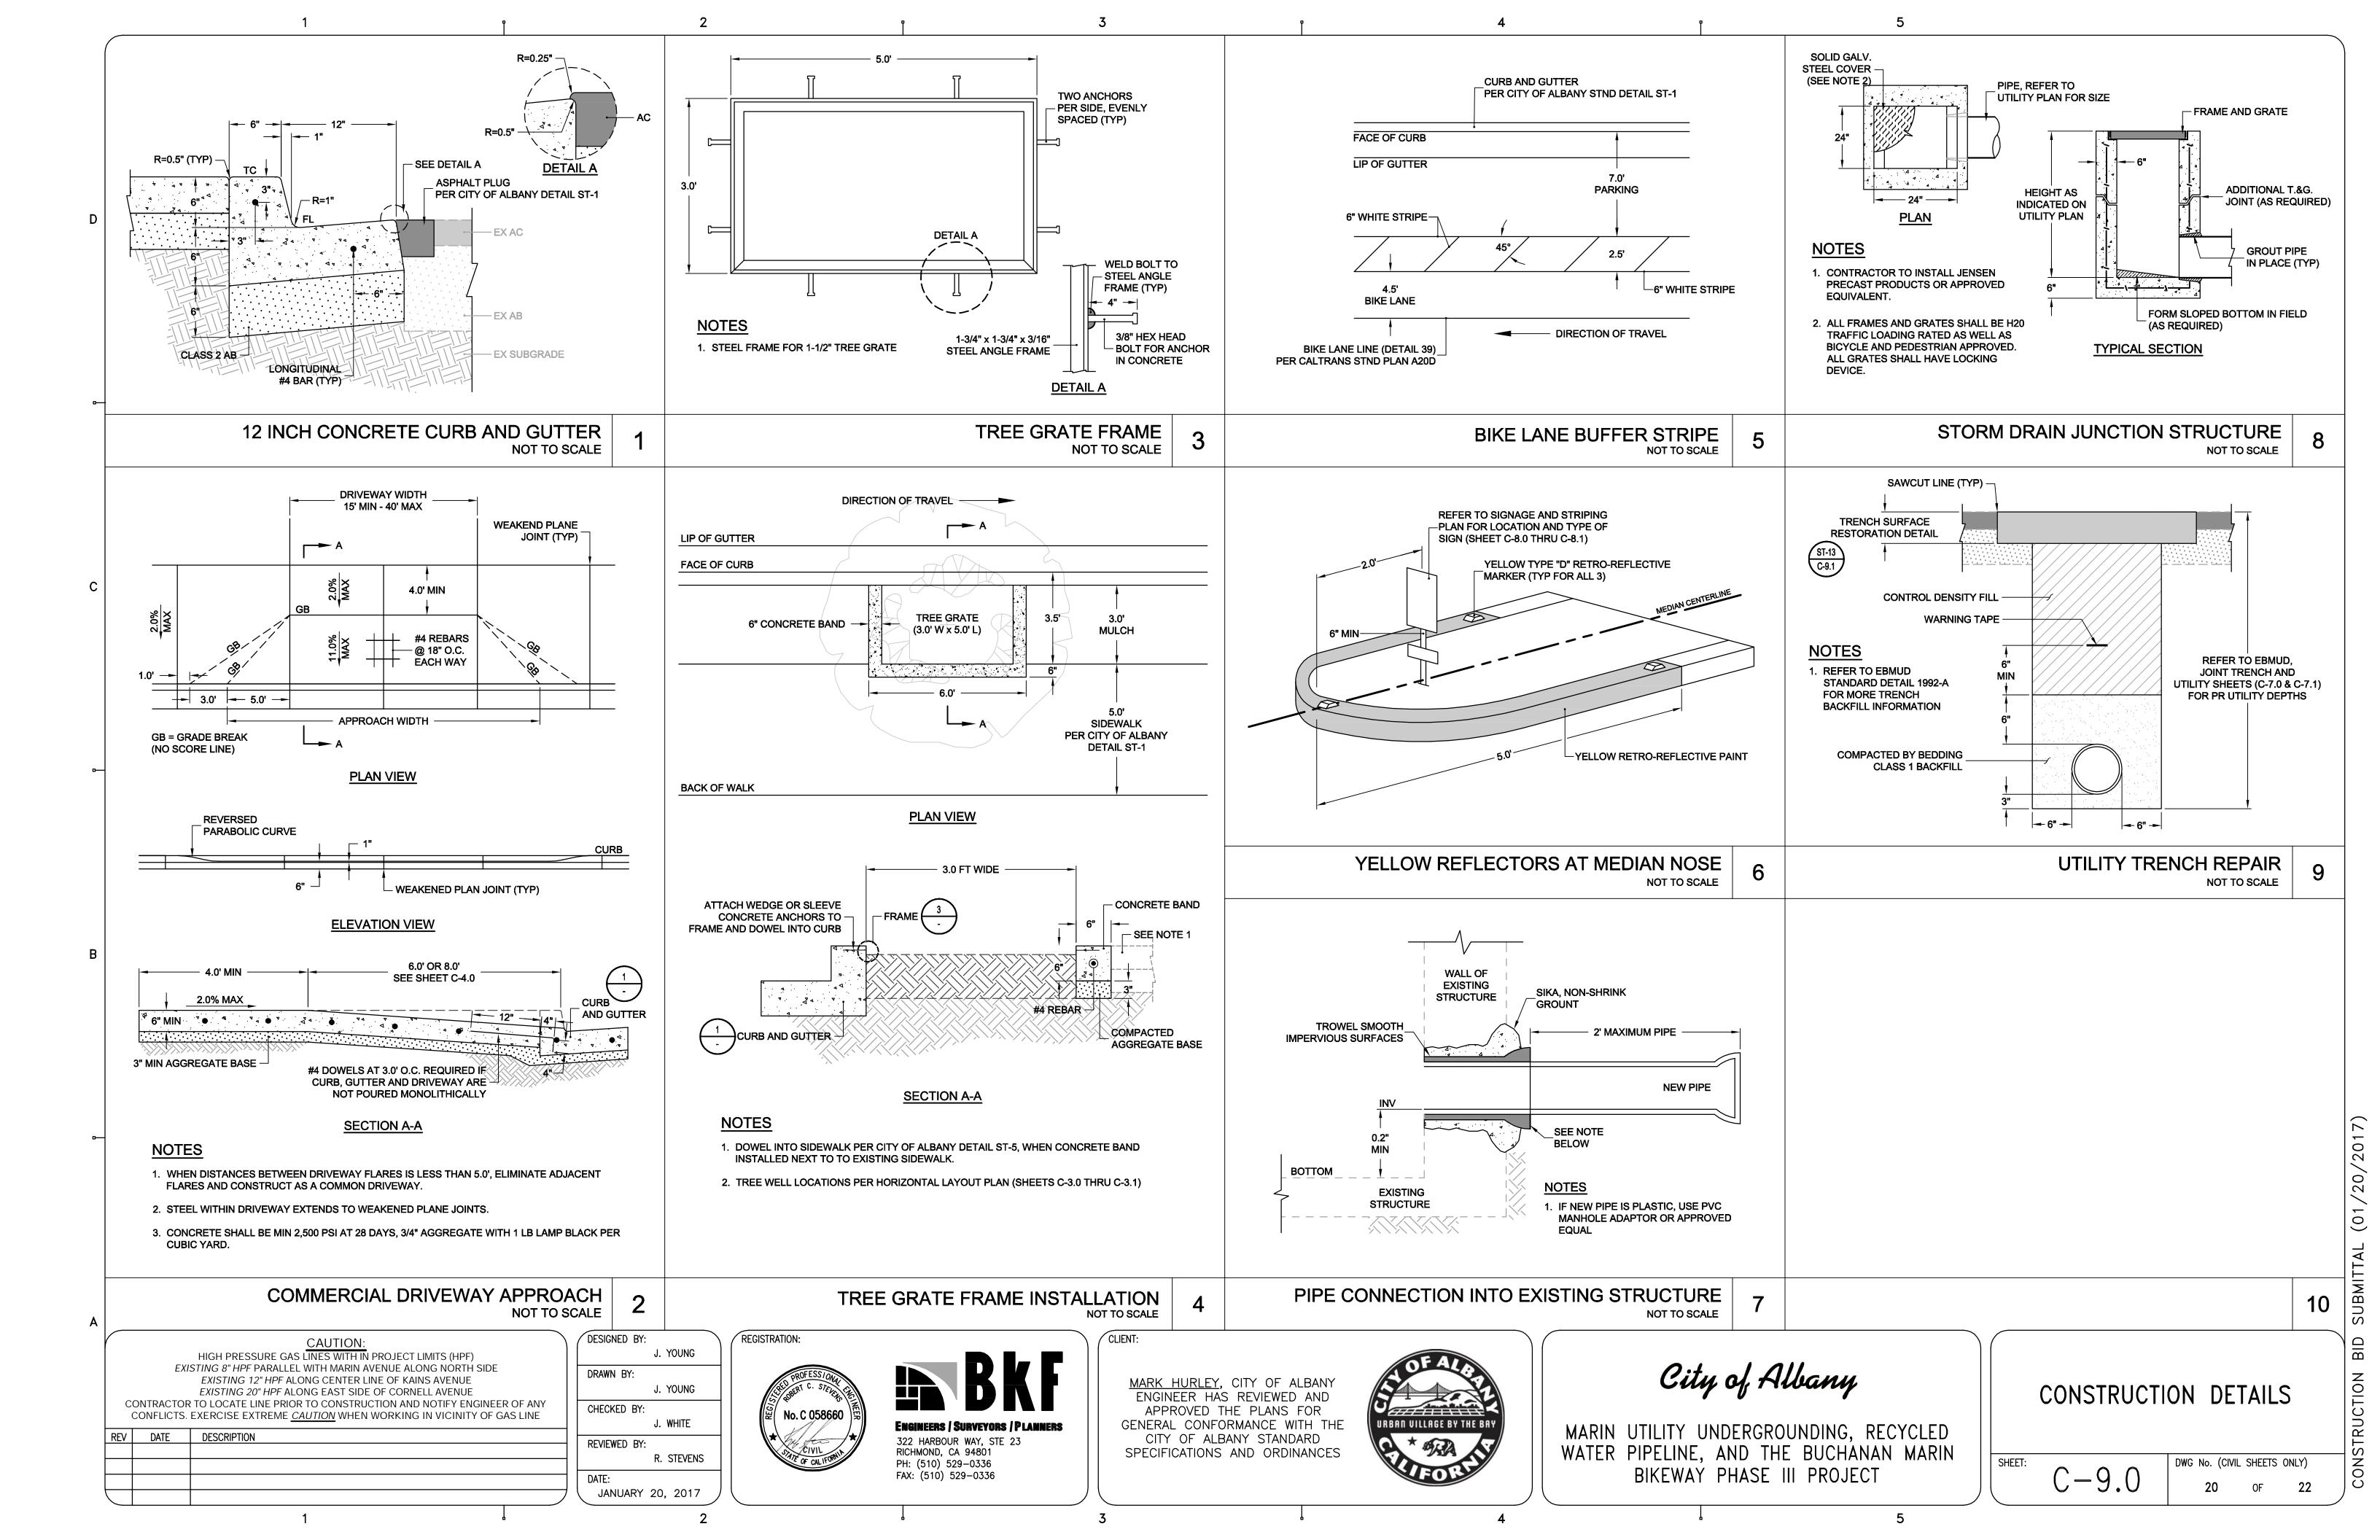
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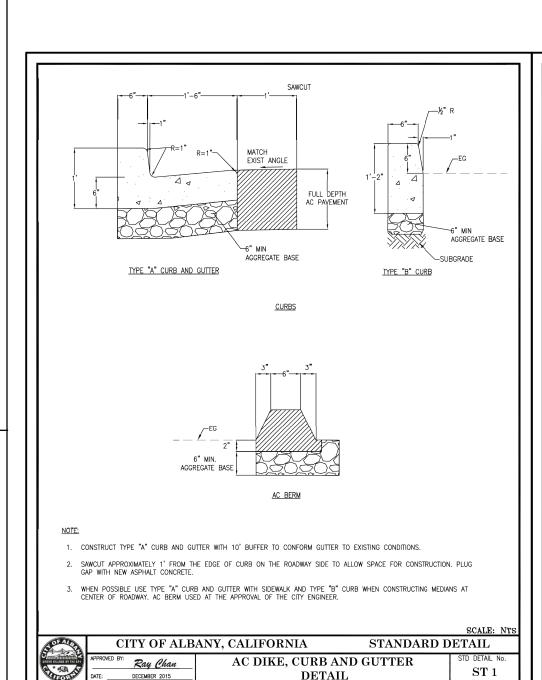
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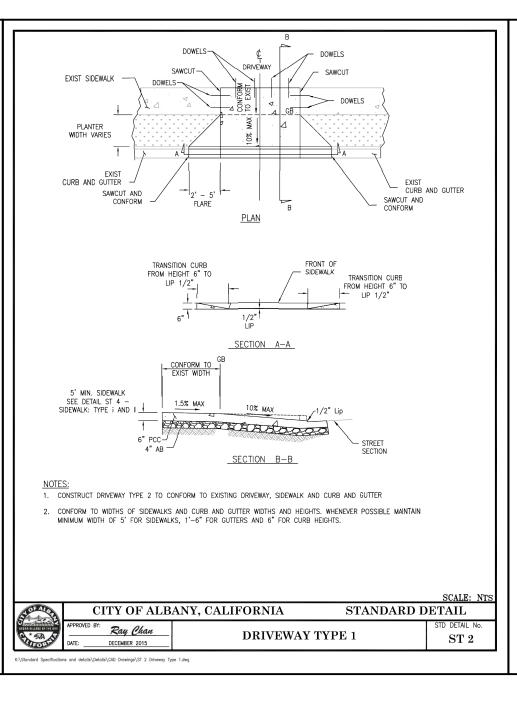
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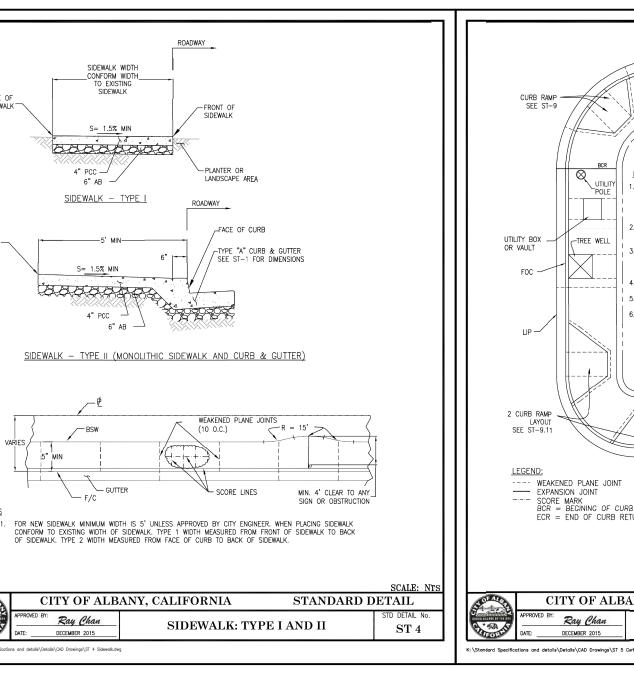
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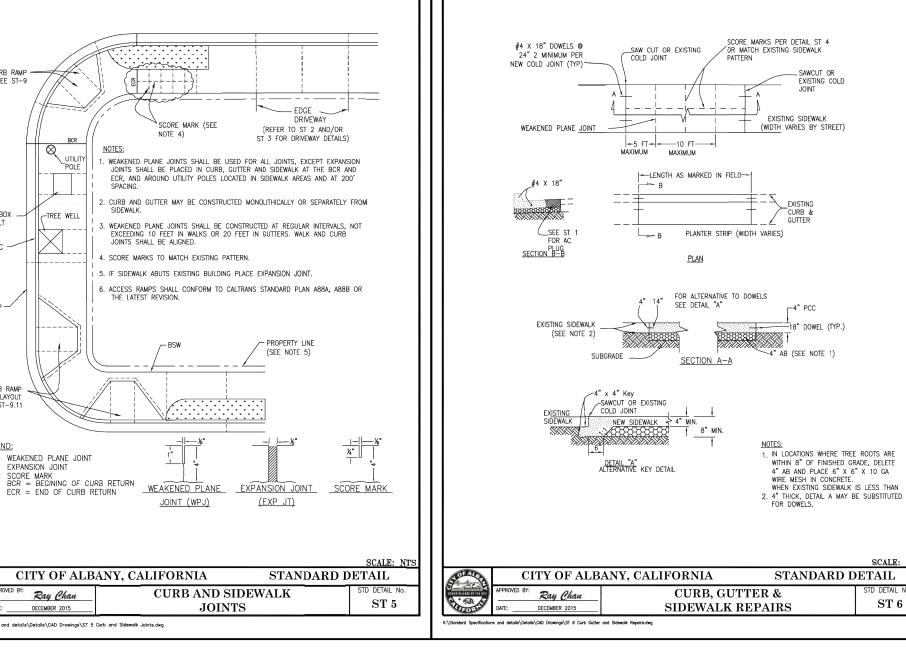
DWG No. (CIVIL SHEETS ONLY) C - 8.1OF 22

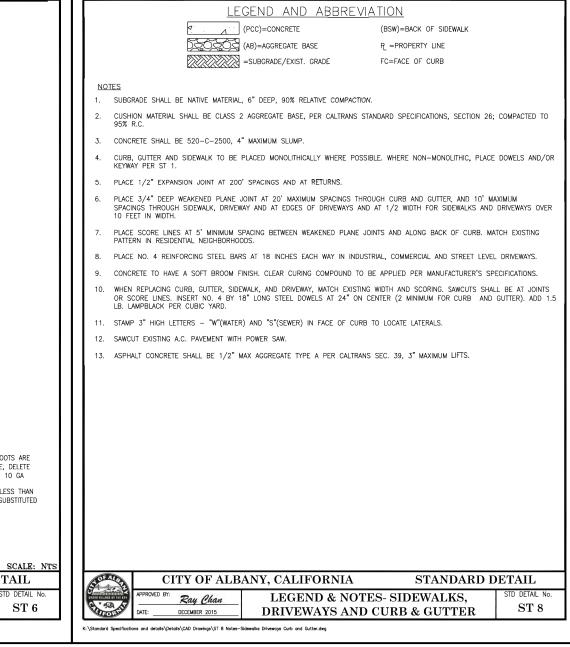


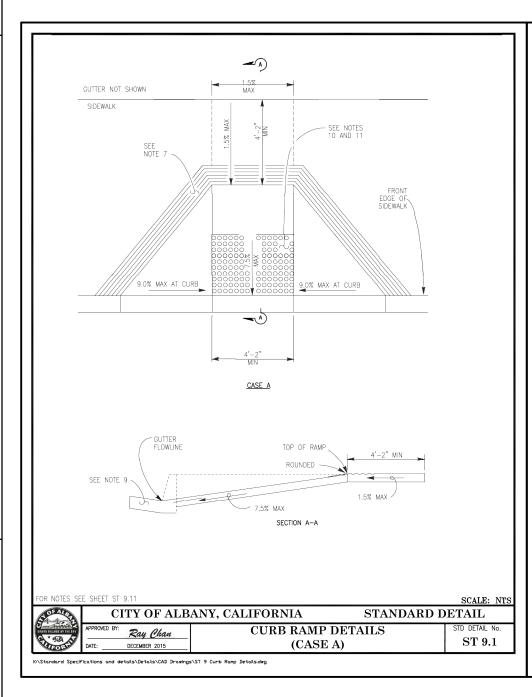


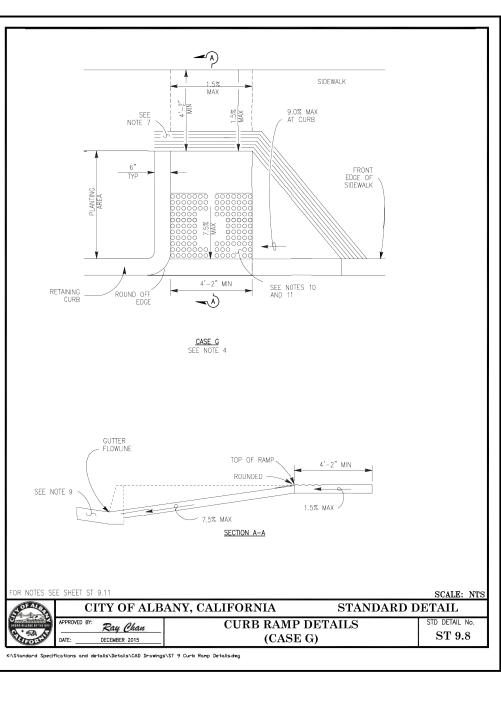


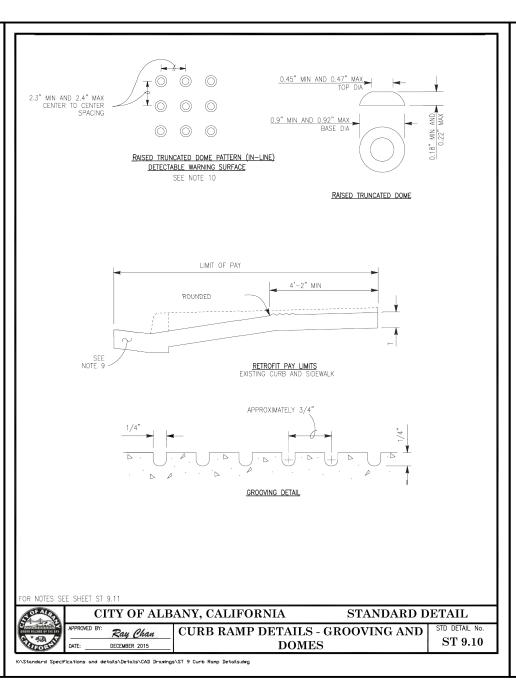


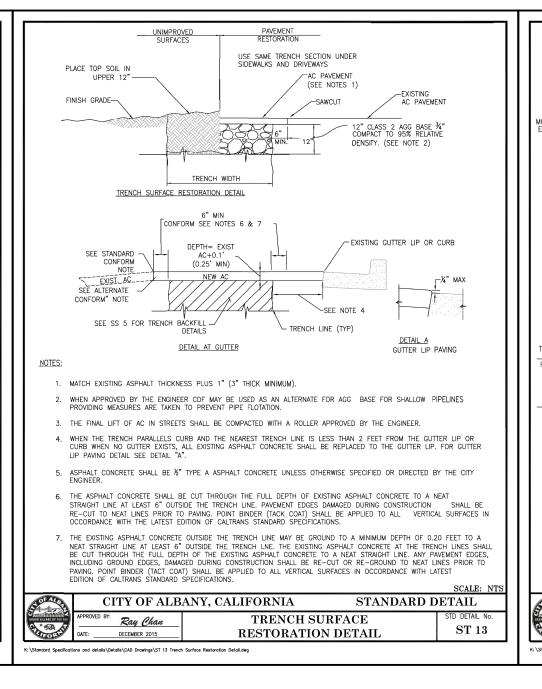


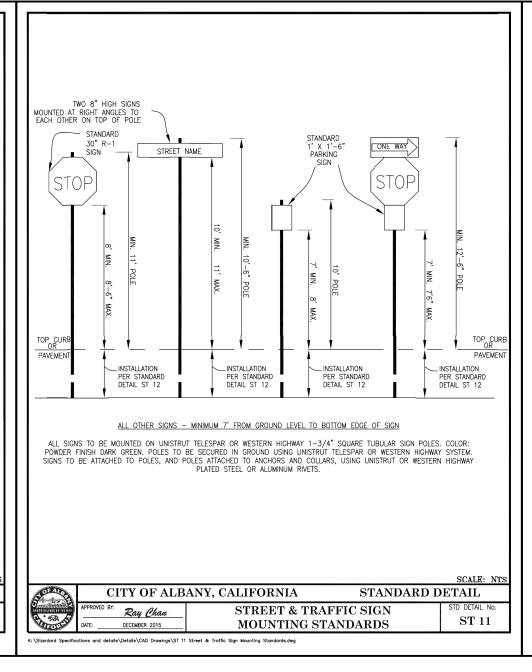


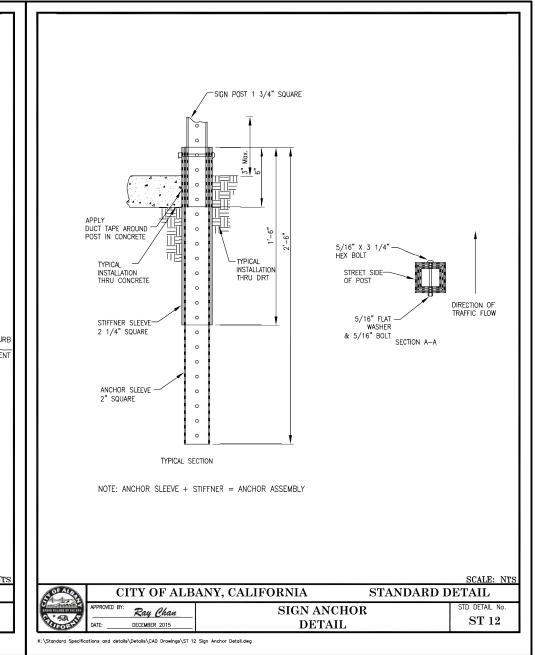












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	REV	DATE	DESCRIPTION

SIGNED BY:			١
	J.	YOUNG	Ì
RAWN BY:			1
	J.	YOUNG	
HECKED BY:			1

JANUARY 20, 2017

REVIEWED BY:

DATE:

J. WHITE


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CONS	TRUCTION	DETAILS
CITY	STANDARD	PLANS

STRUCTION

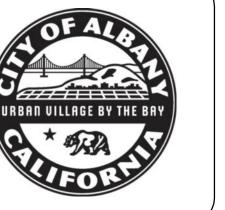DWG No. (CIVIL SHEETS ONLY) C - 9.10F

